For Office Use: Fil	ling Date:	Case Number:	Zoning District:
LIST ALL PROPEI	RTIES INVOLVED IN	YOUR PROJECT:	
530-536 N. Salina	St.		
TAX MAP SECTIO	N, BLOCK, and LOT is	nformation from Assessn	nent Department (call 448-8280)
Section: 08	Block: 18	Lot: 04	
Section:	Block;	Lot:	
Section:	Block:	Lot:	
PROJECT INFORM	IATION: Existing U	Use Propos	sed Use
New Construction			
New Addition	Y-		
Exterior Alteration	Vacant	Gr. floor	retail, upper residential
			rotall, apper rooldontial
✓ Demolition	Selective interior dem		retail, apper residential
PLEASE DESCRIB This project involve	E ALL ASPECTS OF Yes the renovation of an	nolition YOUR PROJECT IN DE existing, triangular four	ETAIL: r-story apartment building
PLEASE DESCRIB This project involve constructed in 189	E ALL ASPECTS OF Yes the renovation of an 6. The existing ground	nolition YOUR PROJECT IN DE existing, triangular four I floor will house retail a	ETAIL: r-story apartment building and/or food service tenants, with
PLEASE DESCRIB This project involve constructed in 189 five apartments on	E ALL ASPECTS OF Yes the renovation of an 6. The existing ground the three floors above	NOUR PROJECT IN DE existing, triangular four I floor will house retail a (two each on the secon	ETAIL:story apartment building and/or food service tenants, with and and third floors; one on the
PLEASE DESCRIB This project involve constructed in 189 five apartments on fourth floor). The e	E ALL ASPECTS OF Yes the renovation of an 6. The existing ground the three floors above existing structure, include	NOUR PROJECT IN DE existing, triangular four I floor will house retail a (two each on the seconding the Basement, is 8	ETAIL: r-story apartment building and/or food service tenants, with and and third floors; one on the s,150 square feet in size. The site
PLEASE DESCRIB This project involve constructed in 189 five apartments on fourth floor). The e	E ALL ASPECTS OF Yes the renovation of an 6. The existing ground the three floors above existing structure, include off-street parking	existing, triangular four floor will house retail a (two each on the seconding the Basement, is 8 g with associated drains	ETAIL: r-story apartment building and/or food service tenants, with and and third floors; one on the state age, new sidewalks, curbs,
PLEASE DESCRIBE This project involve constructed in 1890 five apartments on fourth floor). The education development will in handicapped access	E ALL ASPECTS OF Yes the renovation of an 6. The existing ground the three floors above existing structure, included the control of the contr	existing, triangular four floor will house retail a (two each on the seconding the Basement, is 8 g with associated drains n of existing concrete s	ETAIL:story apartment building and/or food service tenants, with and and third floors; one on the 3,150 square feet in size. The site age, new sidewalks, curbs, stairs. The property is listed on the
PLEASE DESCRIB This project involve constructed in 189 five apartments on fourth floor). The e development will in handicapped acces National Register of	E ALL ASPECTS OF Yes the renovation of an 6. The existing ground the three floors above existing structure, included the control of the contr	existing, triangular four floor will house retail a (two each on the seconding the Basement, is 8 g with associated drains n of existing concrete shas already received Page 100 of 100	ETAIL: r-story apartment building and/or food service tenants, with and and third floors; one on the s,150 square feet in size. The site age, new sidewalks, curbs, stairs. The property is listed on the art 1 approval from the NYS State
PLEASE DESCRIB This project involve constructed in 189 five apartments on fourth floor). The e development will in handicapped acces National Register of	E ALL ASPECTS OF Yes the renovation of an 6. The existing ground the three floors above existing structure, included the control of the contr	existing, triangular four floor will house retail a (two each on the seconding the Basement, is 8 g with associated drains n of existing concrete shas already received Page 100 of 100	ETAIL:story apartment building and/or food service tenants, with and and third floors; one on the 3,150 square feet in size. The site age, new sidewalks, curbs, stairs. The property is listed on the
PLEASE DESCRIB This project involve constructed in 189 five apartments on fourth floor). The e development will in handicapped acces National Register of	E ALL ASPECTS OF Yes the renovation of an 6. The existing ground the three floors above existing structure, included the control of the contr	existing, triangular four floor will house retail a (two each on the seconding the Basement, is 8 g with associated drains n of existing concrete shas already received Page 100 of 100	ETAIL: r-story apartment building and/or food service tenants, with and and third floors; one on the s,150 square feet in size. The site age, new sidewalks, curbs, stairs. The property is listed on the art 1 approval from the NYS State
PLEASE DESCRIB This project involve constructed in 1890 five apartments on fourth floor). The e development will in handicapped access National Register of Historic Preservation	E ALL ASPECTS OF Yes the renovation of an 6. The existing ground the three floors above existing structure, include off-street parking as ramp, and restoration of Historic Places, and the Office and the Nation	existing, triangular four floor will house retail a (two each on the seconding the Basement, is 8 g with associated drains n of existing concrete shas already received Page 100 of 100	ETAIL: r-story apartment building and/or food service tenants, with and and third floors; one on the s,150 square feet in size. The site age, new sidewalks, curbs, stairs. The property is listed on the art 1 approval from the NYS State
PLEASE DESCRIB This project involve constructed in 1896 five apartments on fourth floor). The e development will in handicapped acces National Register of Historic Preservation	E ALL ASPECTS OF Yes the renovation of an 6. The existing ground the three floors above existing structure, include off-street parking as ramp, and restoration of Historic Places, and the Office and the Nation	existing, triangular four floor will house retail a (two each on the seconding the Basement, is 8 g with associated drains of existing concrete shas already received Panal Park Service for His	ETAIL: r-story apartment building and/or food service tenants, with and and third floors; one on the s,150 square feet in size. The site age, new sidewalks, curbs, stairs. The property is listed on the art 1 approval from the NYS State
PLEASE DESCRIB This project involve constructed in 189 five apartments on fourth floor). The e development will in handicapped acces National Register of Historic Preservation DWNER INFORMA Stalwart	E ALL ASPECTS OF Yes the renovation of an 6. The existing ground the three floors above existing structure, include off-street parking as ramp, and restoration of Historic Places, and the Office and the Nation Office and	existing, triangular four floor will house retail a (two each on the seconding the Basement, is 8 g with associated drains n of existing concrete shas already received Panal Park Service for His	ETAIL: r-story apartment building and/or food service tenants, with and and third floors; one on the s,150 square feet in size. The site age, new sidewalks, curbs, stairs. The property is listed on the art 1 approval from the NYS State

APPLICANT INFORMATION: (Copy of contract to purchase must be included with application)
Contract Purchaser(s) Tenant Co-Applicant Other (please state):
Name(s):
Mailing Address:
E-mail:
REPRESENTATIVE INFORMATION: (Only if involved in this application)
Attorney Architect Contractor Other
Name(s): James F. Williams AIA / Holmes King Kallquist & Associates, Architects
Mailing Address: 575 N. Salina St., Syracuse, NY
Zip: 13208 Telephone: 315-476-8371 E-mail: jwilliams@hkkarchitects.com
SIGNAGE INFORMATION: Refer to attached Encroachment Plan En1.2 and Elevation En2.1. Size and location of all existing AND proposed signage (use additional sheet if necessary) A sign plan is required, see attachment. (Wall, Ground, Projecting, Window)
Size 6'-0"w x 4'-0"h Location 2nd floor, N. Salina St. Type Existing, Projecting
Size 6'-0"w x 4'-0"h Location 2nd floor, N. Salina St. Type Proposed, Projecting
Size Location Type
1) po
DECLARATION:
I understand that false statements made herein are punishable as a Class A Misdemeanor, pursuant to section 210.45 of the Penal Law of the State of New York. I declare that, subject to the penalties of perjury, any
statements made on this application and any attachments are the truth and to the best of my knowledge correct.
I also understand that any false statements and/or attachments presented knowingly in connection with this
application will be considered null and void.
2:3-020
Signature of CURRENT PROPERTY OWNER Date
(or owner's LEGAL representative)
Irfan Elahi
PRINT NAME OF PROPERTY OWNER
*Please note that if referrals are necessary for this application, additional copies of all required materials will be requested.
FOR STAFF USE ONLY

ONONDAGA COUNTY PLANNING BOARD SYRACUSE LANDMARK PRESERVATION BOARD (This project is
located within Historic District; is listed individually in the National Register of Historic Places; is Eligible for
inclusion in the National Register of Historic Places; or is architecturally significant) OTHER CITY/COUNTY/STATE AGENCY OR DEPARTMENT(S)

Short Environmental Assessment Form Part 1 - Project Information

Instructions for Completing

Part 1 – Project Information. The applicant or project sponsor is responsible for the completion of Part 1. Responses become part of the application for approval or funding, are subject to public review, and may be subject to further verification. Complete Part 1 based on information currently available. If additional research or investigation would be needed to fully respond to any item, please answer as thoroughly as possible based on current information.


Complete all items in Part 1. You may also provide any additional information which you believe will be needed by or useful to the lead agency; attach additional pages as necessary to supplement any item.

Par	rt 1 – Project an	d Sponsor Information							
Naı	me of Action or I	Project:							
Pro	ject Location (de	escribe, and attach a location r	nap):						
Brio	ef Description of	F Proposed Action:							
Naı	ne of Applicant	or Sponsor:			Telephon	ne:			
					E-Mail:				
Ado	dress:								
City	y/PO:				State:		Zip C	ode:	
1.		sed action only involve the legrule, or regulation?	gislative adoption	of a plan, loca	l law, ordi	nance,		NO	YES
	es, attach a narr	ative description of the intent he municipality and proceed to				tal resources th	at		
2. Does the proposed action require a permit, approval or funding from any other government Agency? If Yes, list agency(s) name and permit or approval:				NO	YES				
	, ,	, 11							
3.		e of the site of the proposed ac e to be physically disturbed?	tion?			eres eres			
c. Total acreage (project site and any contiguous properties) owned or controlled by the applicant or project sponsor?									
4. Check all land uses that occur on, are adjoining or near the proposed action:									
5.	Urban	Rural (non-agriculture)	Industrial	Commercia	al Re	sidential (subur	ban)		
	☐ Forest	Agriculture	Aquatic	Other(Spec	eify):				
	☐ Parkland								

Page 1 of 3 SEAF 2019

5.	Is the proposed action,	NO	YES	N/A
	a. A permitted use under the zoning regulations?			
	b. Consistent with the adopted comprehensive plan?			
			NO	YES
6.	Is the proposed action consistent with the predominant character of the existing built or natural landso	:ape?		
7.	Is the site of the proposed action located in, or does it adjoin, a state listed Critical Environmental Are	a?	NO	YES
If Y	Yes, identify:			
			110	
8.	a. Will the proposed action result in a substantial increase in traffic above present levels?		NO	YES
	b. Are public transportation services available at or near the site of the proposed action?		H	
	c. Are any pedestrian accommodations or bicycle routes available on or near the site of the propose action?	ed		
9.			NO	YES
If t	the proposed action will exceed requirements, describe design features and technologies:			
10.	. Will the proposed action connect to an existing public/private water supply?		NO	YES
	If No, describe method for providing potable water:			
11.	. Will the proposed action connect to existing wastewater utilities?		NO	YES
	If No, describe method for providing wastewater treatment:			
	a. Does the project site contain, or is it substantially contiguous to, a building, archaeological site, or contains a substantially contiguous to, a building, archaeological site, or contains a substantially contiguous to, a building, archaeological site, or contains a substantially contiguous to, a building, archaeological site, or contains a substantially contiguous to, a building, archaeological site, or contains a substantially contiguous to, a building, archaeological site, or contains a substantially contains a substantially contiguous to, a building, archaeological site, or contains a substantially contains a substantially contains a substantially contains a substantially contains a substantial	listrict	NO	YES
Co	nich is listed on the National or State Register of Historic Places, or that has been determined by the ommissioner of the NYS Office of Parks, Recreation and Historic Preservation to be eligible for listing cate Register of Historic Places?	n the		
	b. Is the project site, or any portion of it, located in or adjacent to an area designated as sensitive for chaeological sites on the NY State Historic Preservation Office (SHPO) archaeological site inventory?			
13.	a. Does any portion of the site of the proposed action, or lands adjoining the proposed action, conta wetlands or other waterbodies regulated by a federal, state or local agency?	in	NO	YES
	b. Would the proposed action physically alter, or encroach into, any existing wetland or waterbody?		一	
If Y	Yes, identify the wetland or waterbody and extent of alterations in square feet or acres:			
_				

14. Identify the typical habitat types that occur on, or are likely to be found on the project site. Check all that apply:		
Shoreline Forest Agricultural/grasslands Early mid-successional		
☐ Wetland ☐ Urban ☐ Suburban		
15. Does the site of the proposed action contain any species of animal, or associated habitats, listed by the State or Federal government as threatened or endangered?		
	✓	
17. Will the proposed action create storm water discharge, either from point or non-point sources? If Yes,	NO	YES
a. Will storm water discharges flow to adjacent properties?	7	
b. Will storm water discharges be directed to established conveyance systems (runoff and storm drains)?		V
If Yes, briefly describe:		
Storm water will be discharged to existing subsurface municipal combined sanitary and storm pipe.		
18. Does the proposed action include construction or other activities that would result in the impoundment of water or other liquids (e.g., retention pond, waste lagoon, dam)?	NO	YES
If Yes, explain the purpose and size of the impoundment:	V	
19. Has the site of the proposed action or an adjoining property been the location of an active or closed solid waste	NO	YES
management facility? If Yes, describe:	NO	IES
	V	
20. Has the site of the proposed action or an adjoining property been the subject of remediation (ongoing or completed) for hazardous waste?	NO	YES
If Yes, describe:		
Interior asbestos removal (non-friable and friable).		V
I CERTIFY THAT THE INFORMATION PROVIDED ABOVE IS TRUE AND ACCURATE TO THE B MY KNOWLEDGE	EST OF	7
Applicant/sponsor/name: Irfan Elahi Date: 02-04-2020		
Signature:Title: President		

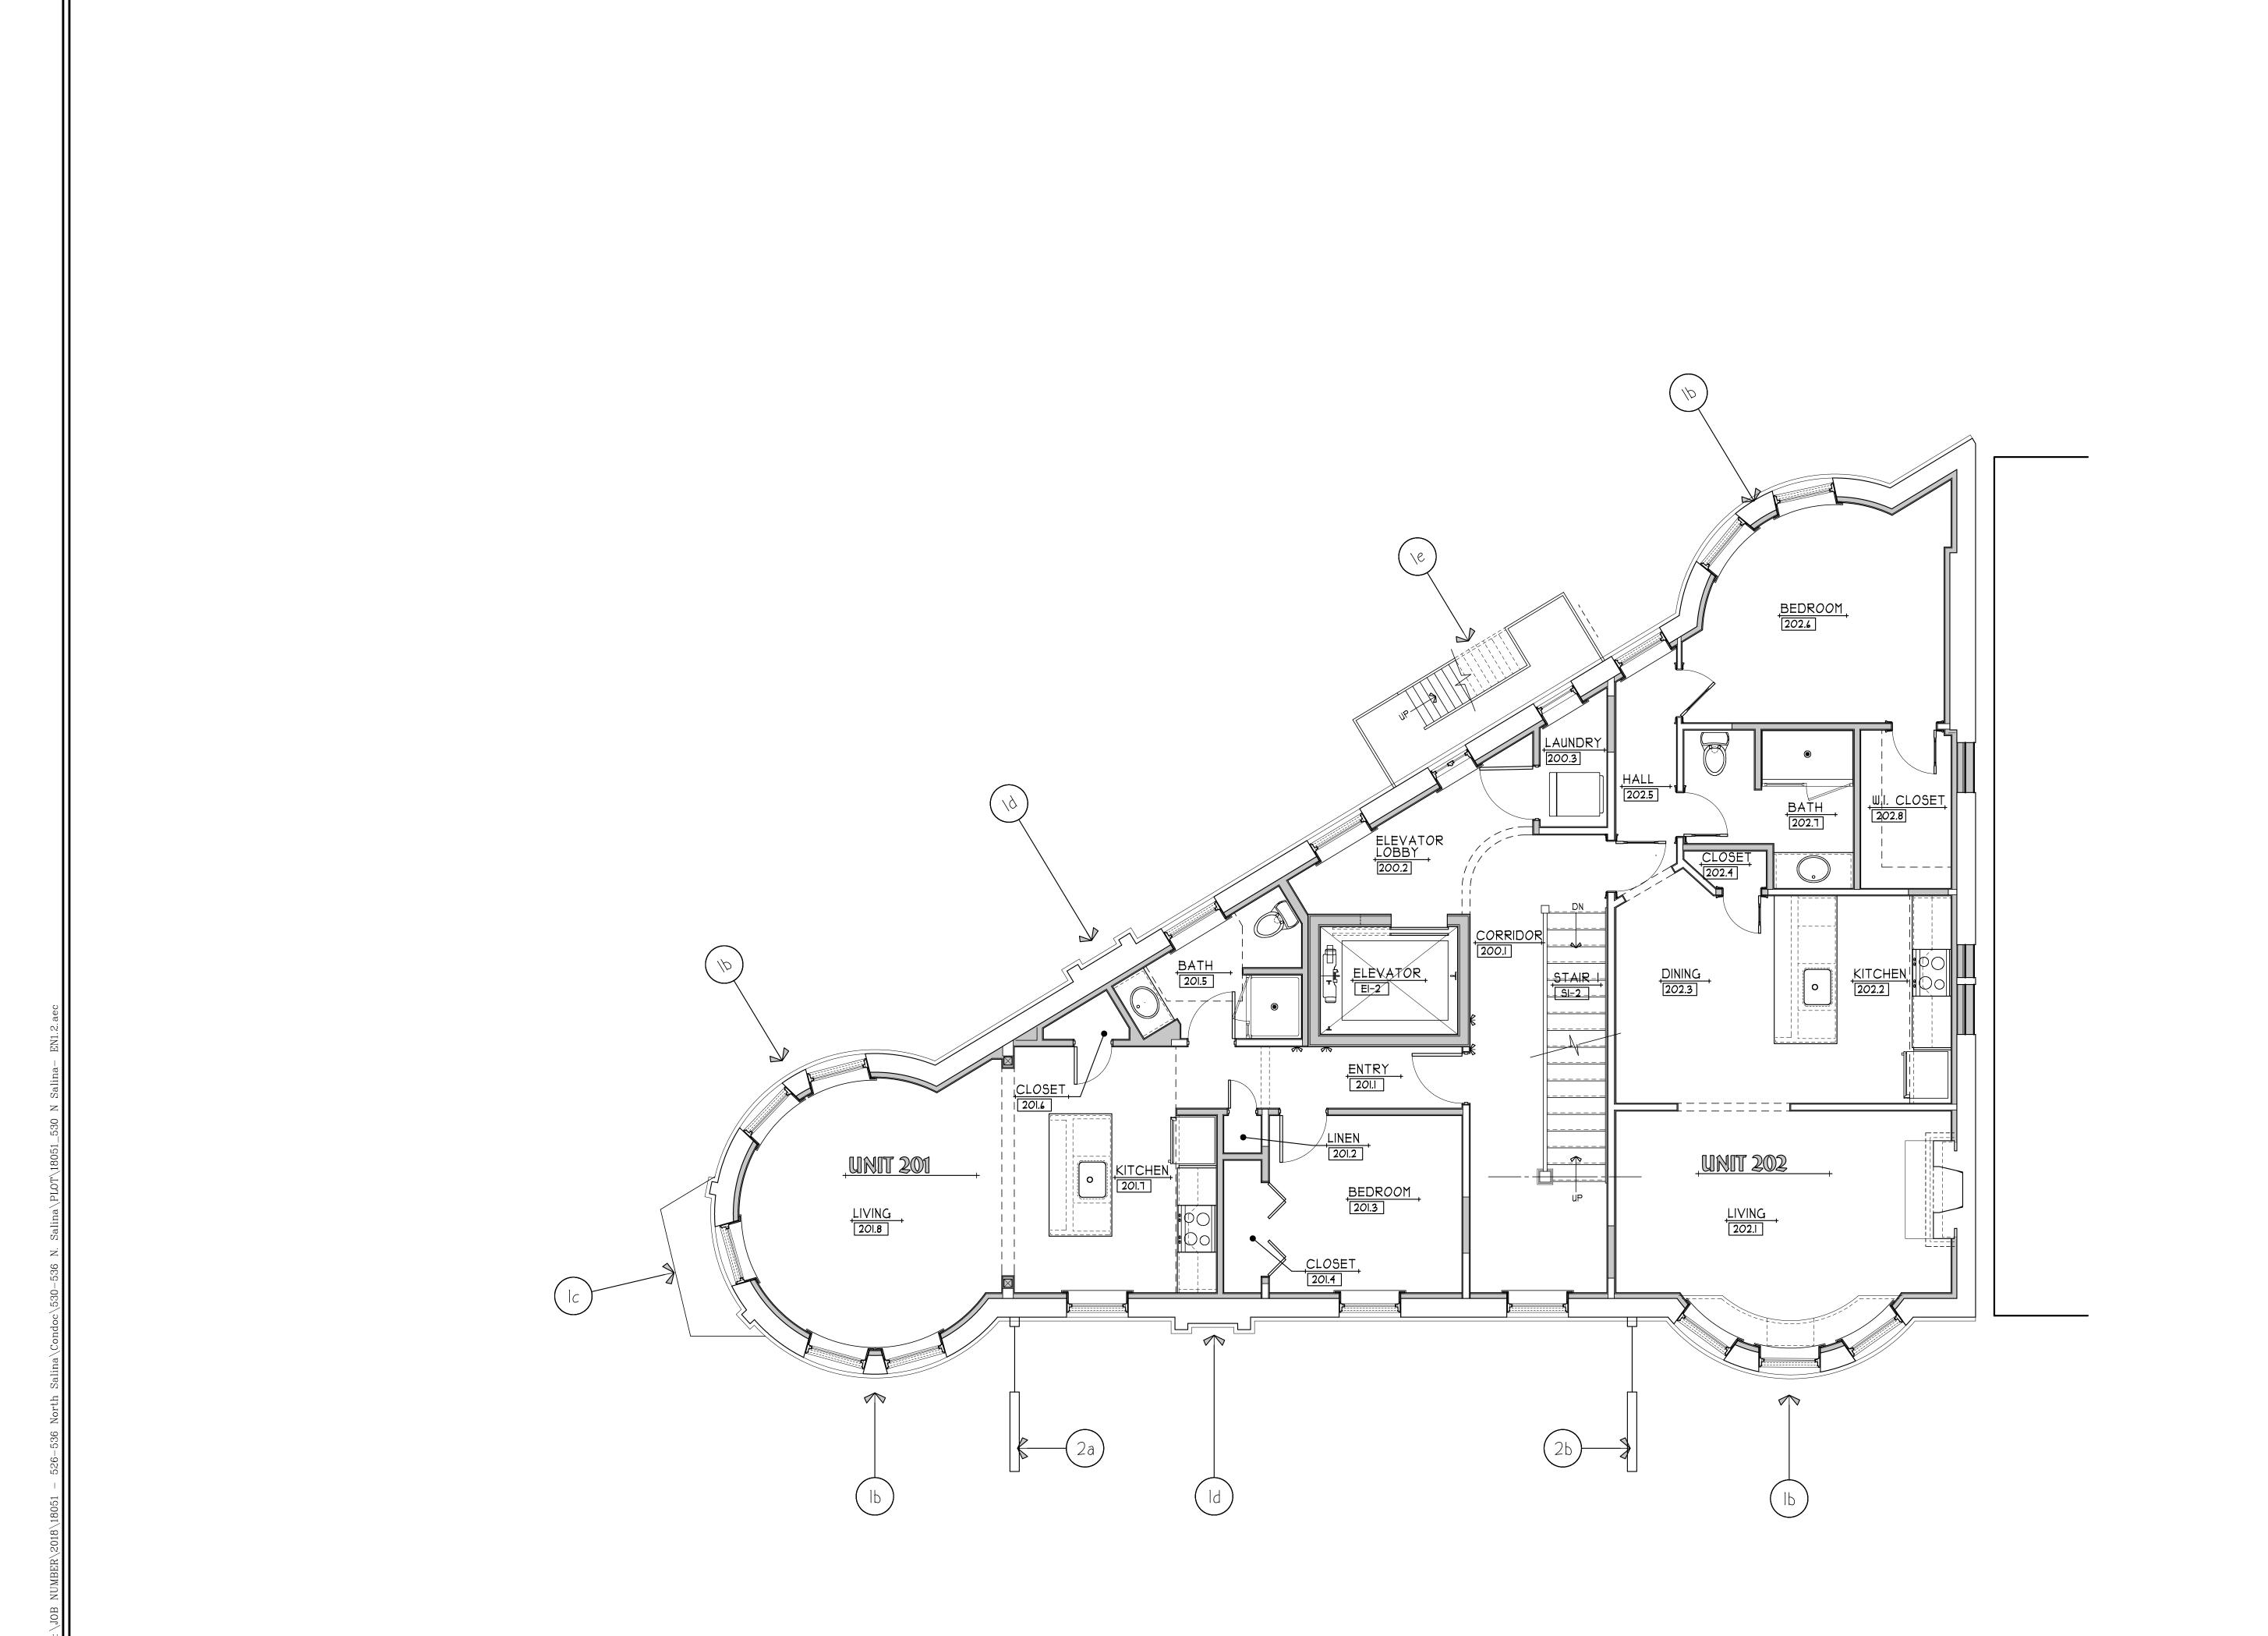

ALL DRAWINGS AND SPECIFICATIONS ARE THE PROPERTY OF THE ARCHITECT, AND SHALL BE USED ONLY ON THE JOB DESIGNATED. COPYRIGHT © THE CONTRACTOR SHALL VERIFY ALL DIMENSIONS AT THE SITE AND PROMPTLY NOTIFY THE ARCHITECT IN WRITING OF ANY DISCREPANCIES.

PROJECT NORTH

JOB NO: 18051 DATE: 12/20/2019 DRAWN BY: TEF SCALE: AS NOTED

HISTOR 530-536 --536 NORTH SA

SECOND FLOOR PLAN



PROJECT NUMBER: 18.8702

<u>LEGEND</u> ----- SIGN BOL o ----- BOLLARD SMH O ----- SANITARY MANHOLE DMH O ----- DRAINAGE MANHOLE CB ☐ ------ SQUARE CATCH BASIN └─Ø ----- UTILITY POLE W/ LIGHT Ø ----- UTILITY POLE HYD **₫** ----- HYDRANT WV o ----- WATER VALVE GV o ----- GAS VALVE EMH O ----- ELECTRIC MANHOLE TMH O ----- TELEPHONE MANHOLE ----- DECIDUOUS TREE CO O ----- CLEANOUT LP • ----- LIGHT POLE

------ BURIED TELEPHONE LINE ----- OVERHEAD WIRES ----- GAS LINE

----- WATER LINE

----- STORM SEWER LINE ----- SANITARY SEWER LINE

← — ----- GUY WIRE ------ BURIED ELECTRIC LINE

TSB $_{\square}$ ------ TRAFFIC SIGNAL BOX City Mon. O ------ CITY MONUMENT FOUND

1.) NORTH ORIENTATION IS BASED ON THE CITY OF SYRACUSE RIGHT OF WAY PLATS..

2.) VERTICAL DATUM IS BASED ON CITY OF SYRACUSE DATUM.

3.) THIS SURVEY WAS PREPARED WITHOUT THE BENEFIT OF AN ABSTRACT OR UP TO DATE TITLE REPORT AND IS THEREFORE SUBJECT TO ANY EASEMENTS, RESTRICTIONS, COVENANTS OR ANY STATEMENT OF FACTS THAT SUCH DOCUMENTS MAY DISCLOSE.

4.) UNDERGROUND FACILITIES, STRUCTURES AND UTILITIES HAVE BEEN PLOTTED FROM DATA OBTAINED BY FIELD SURVEY, PREVIOUS MAPS AND RECORDS, (AND PAROLE TESTIMONY). THEREFORE THEIR LOCATIONS MUST BE CONSIDERED APPROXIMATE ONLY. THERE MAY BE OTHER UNDERGROUND UTILITIES, THE EXISTENCE OF WHICH ARE NOT KNOWN TO THE UNDERSIGNED. SIZE AND LOCATION OF ALL UNDERGROUND UTILITIES AND STRUCTURES MUST BE VERIFIED BY THE APPROPRIATE AUTHORITIES

PRIOR TO ANY CONSTRUCTION. 5.) FIELD WORK PERFORMED ON JANUARY 3, 2019.

MAP REFERENCES

TRUE COPY".

1.) LOCATION SURVEY ON PART OF BLOCK No. 10 CITY OF SYRACUSE PREPARED BY LEHR LAND SURVEYORS DATED SEPT. 10, 2003 AND REDATED JANUARY 21, 2015.

1 inch = 20 ft.

"ONLY COPIES OF THIS MAP SIGNED IN RED INK AND EMBOSSED WITH THE SEAL OF AN OFFICER OF C.T. MALE ASSOCIATES OR A DESIGNATED REPRESENTATIVE SHALL BE CONSIDERED TO BE A VALID

I CERTIFY THAT THIS SURVEY WAS PREPARED FROM AN ACTUAL FIELD SURVEY AND IS CORRECT TO THE BEST OF MY KNOWLEDGE AND HAS BEEN PREPARED IN ACCORDANCE WITH THE EXISTING CODE OF PRACTICE OF THE N.Y.S. ASSOCIATION OF PROFESSIONAL LAND SURVEYORS.

DAVID M. SLISKI PLS # 50105

01/25/2019

DATE REVISIONS RECORD/DESCRIPTION DRAFTER CHECK P.L.S. NO. 50105

R.O. - Irfan Elahi D.B. 5326, Pg. 179 TM 8-18-03

R.O. - SHA 2013, LLC D.B. 5287, Pg. 931

TM 8-18-02

R.O. - St. Joseph's Health Center Properties, Inc. D.B. 5226, Pg. 56

TM 8-18-01

BOUNDARY AND TOPOGRAPHIC SURVEY MAP FOR THE LANDS NOW OR FORMERLY OF THE SYRACUSE FLATIRON, LLC 530 NORTH SALINA STREET

PART OF CITY BLOCK 10

+ 60.75 TC 61.57 BC 61.24 TC 61.34 BC 61.00 TC 61.34 BC 60.84 61.54 Curb Cut


TC 61.26 ² BC 60.76

ONONDAGA COUNTY, NEW YORK

C.T. MALE ASSOCIATES Engineering, Surveying, Architecture, Landscape Architecture & Geology, D.P.C. 50 CENTURY HILL DRIVE, LATHAM, NY 518.786.7400

City Mon.

SHEET 1 OF 1 DWG. NO: 19-0133

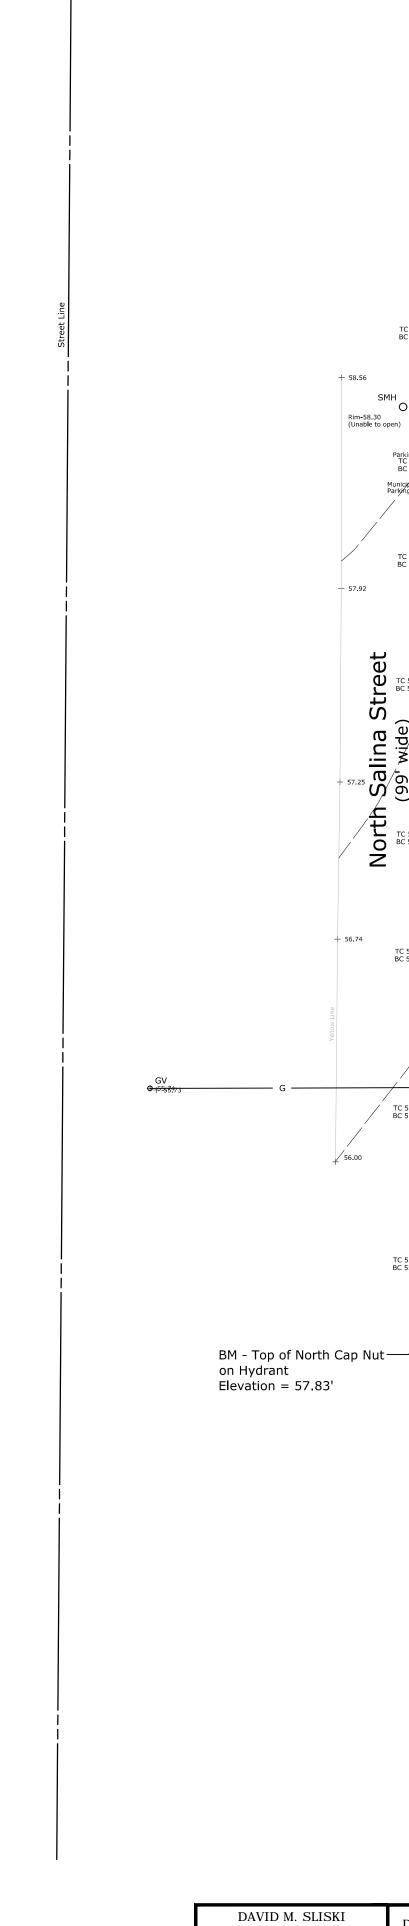

Elevation = 57.83'

_____55.89

C.T. MALE ASSOCIATES APPROVED: DRAFTED : DMS CHECKED : DMS PROJ. NO: 18.8702 SCALE: 1'' = 20 FT.

BOL CB

+ 58.32

+ 58.45

+ 58.76

UNAUTHORIZED ALTERATION OR

ADDITION TO THIS DOCUMENT IS A VIOLATION OF THE NEW YORK STATE

EDUCATION LAW.

© 2019


DATE: JAN. 25, 2019

+ 58.55

CITY OF SYRACUSE

+ 60.54

COBLESKILL, NY • GLENS FALLS, NY • HIGHLAND, NY • JOHNSTOWN, NY LITTLE FALLS, NY • RED HOOK, NY • SYRACUSE, NY

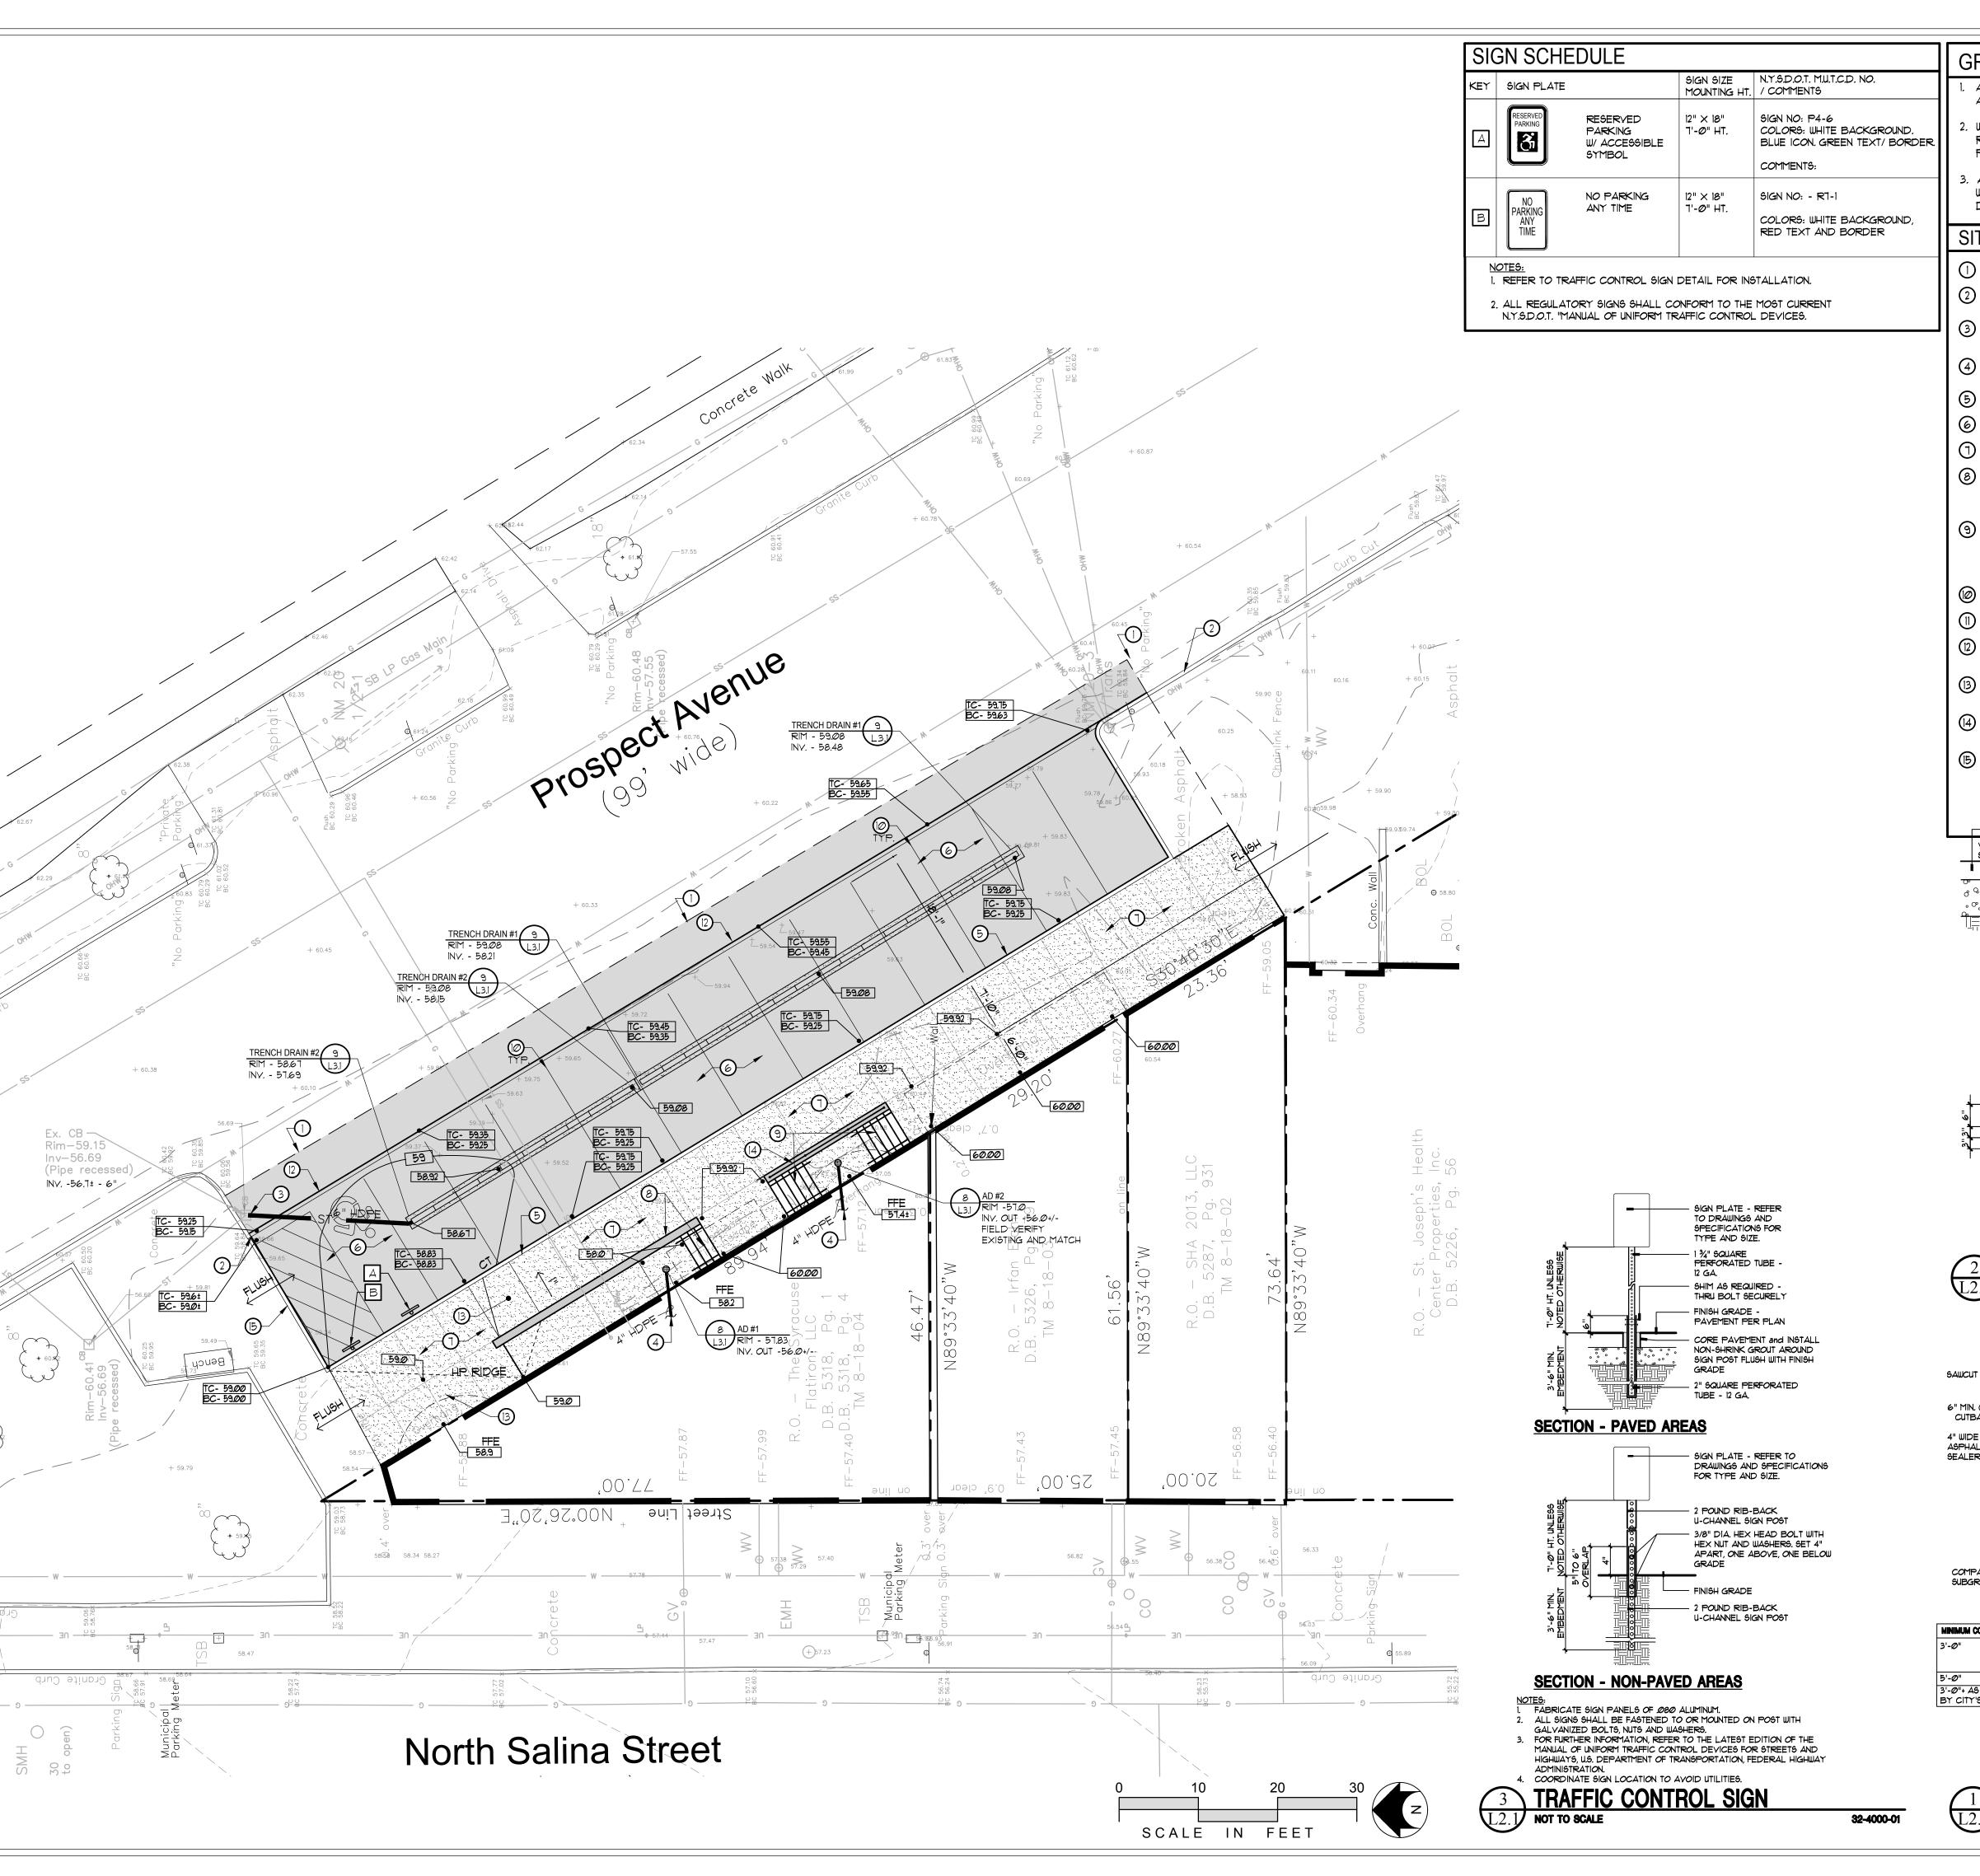

GRADING, DRAINAGE & UTILITY GENERAL NOTES

ANY/ALL FILL REQUIRED BELOW PAVING SUBGRADE SHALL ONLY BE COARSE


AGGREGATE FILL OR SUBBASE COURSE MATERIALS.


WHEREVER EXISTING STORM STRUCTURES ARE TO BE ABANDONED AND REMOVED, CUT AND PLUG CONNECTING PIPES AND/OR REMOVE PORTIONS OF PIPES WHICH MAY INTERFERE WITH OTHER WORK.

. ALL CONCRETE PAYING AT ALL EXISTING AND NEW DOORS SHALL BE FLUSH WITH BUILDING FLOOR ELEVATION. CONCRETE PAVEMENT SHALL BE DOWELED TO FOUNDATION WALL PER DETAILS.


SITE PLAN KEYNOTES

- (1) MEET EXISTING LINE AND GRADE.
- (2) MEET TOP AND FACE OF EXISTING CURB.
- 3 CORE DRILL OPENING INTO EXISTING STRUCTURE FOR INSTALLATION OF NEW STORM PIPE. PROVIDE SILT-TIGHT SEAL.
- 4-INCH HDPE PIPE FROM AREA DRAIN TO BE RECONNECTED TO EXISTING PIPES WITHIN BUILDING. COORDINATE WITH MEP DRAWINGS.
- (5) INSTALL GRANITE CURB WITH 6" REVEAL PER DETAIL 2/L2.1.
- (6) INSTALL ASPHALT PARKING PAVEMENT PER DETAIL 1/L3.1.
- 1) INSTALL CONCRETE PAVEMENT PER DETAIL 2/L3.1.
- (8) INSTALL STONE STAIRS AND STONE RETAINING WALL, STAIRS SHALL HAVE NOMINAL THREE 1" RISERS WITH 11-INCH MINIMUM TREADS. INSTALL STAINLESS STEEL HANDRAILS ON BOTH SIDES OF STAIRS.
- (9) INSTALL STONE STAIRS AND STONE RETAINING WALL UTILIZING EXISTING STONES AND NEW STONES WITH SIMILAR COLOR, SIZE, TEXTURE. STAIRS SHALL HAVE NOMINAL FIVE 6-1/4" RISERS AND 11-INCH MINIMUM TREADS. INSTALL STAINLESS STEEL HANDRAILS ON BOTH SIDES OF STAIRS.
- (1) 4-INCH WIDE PAINTED LINE. TYPICAL.
- (II) INSTALL RESERVED PARKING STALL PER DETAIL 1/L3.1.
- 12 INSTALL SALVAGED/STOCKPILED AND NEW GRANITE CURB PER DETAIL 2/L2.1 WITH 1 1/2 INCH REVEAL.
- (3) FINE GRADE CONCRETE SURFACING TO DIRECT STORMWATER RUNOFF AWAY FROM DOORWAY AND AROUND NORTHEAST CORNER OF BUILDING.
- (14) INSTALL STAINLESS STEEL GUARDRAIL WITH BALLASTERS 4-INCHES ON CENTER ALONG TOP OF RETAINING WALL.
- (15) CAREFULLY REMOVE EXISTING PAYERS AND STOCKPILE AS REQUIRED TO INSTALL NEW GRANITE CURB. INSTALL GRANITE CURB. REINSTALL PAVERS FLUSH WITH TOP OF GRANITE CURB. TOP OF GRANITE CURB SHALL BE INSTALLED AT SAME ELEVATION AS PAVERS. NEW ASPHALT ELEVATION THAT ADJOINS CURB SHALL TRANSITION FROM FLUSH NEAR BUILDING TO 6"+/-NEAR EXISTING CATCH BASIN. FINISH GRADE, MATERIAL

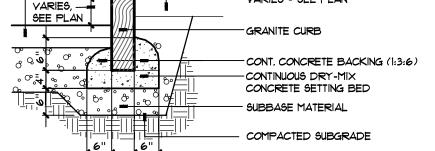

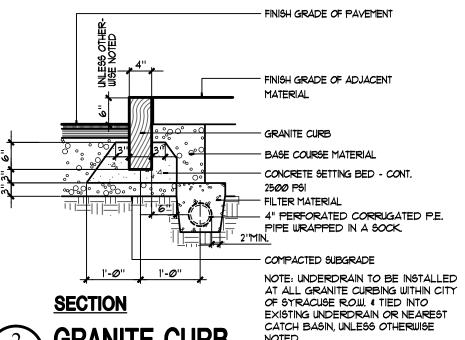



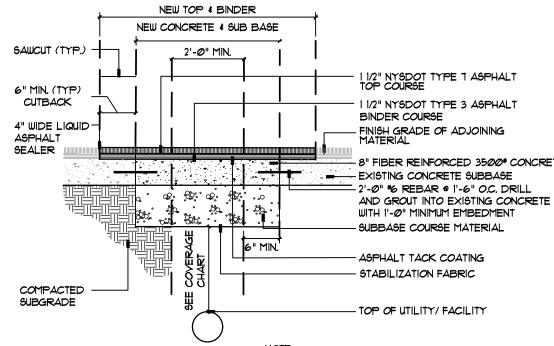

CABLE, TV, TELECOMMUNICATIONS 3'-0"+ AS DIRECTED ALL OTHERS
BY CITY'S ENGINEER

NOTE:

1. IN NO CASE SHALL THE TOP OF CONCRETE BASE BE HIGHER THAN THAT OF THE SURROUNDING EXISTING 2. IF PAVEMENT MARKINGS OR SIGNAL LOOPS ARE DISTURBED OR DESTROYED THEY SHALL BE REPLACED IN ACCORDANCE WITH THE CITY OF SYRACUSE STANDARDS. B. MATCH EXISTING PAVEMENT SLOPE. 4. IF, IN THE OPINION OF THE CONTRACTOR, THE EXISTING CONCRETE FOUNDATION IS IN POOR CONDITION, THE ENGINEER SHALL BE CONTACTED FOR PRIOR APPROVAL TO ELIMINATE DOWELS.

32-1216-03C

32-1640-06

ASPHALT REPAIR- CONCRETE BASE

CITY OF SYRACUSE

LANDSCAPE ARCHITECTURE & LAND PLANNING


6320 FLY ROAD, SUITE 109 EAST SYRACUSE, NEW YORK 13057

PHONE: (315) 445-7980 FAX: (315) 445-7981

PERMIT SET

DRAWN | DESCRIPTION : REV DATE: ALL DRAWINGS AND SPECIFICATIONS ARE THE PROPERTY OF THE ARCHITECT, AND SHALL BE USED ONLY ON THE JOB DESIGNATED. COPYRIGHT (C) THE CONTRACTOR SHALL VERIFY ALL DIMENSIONS


AT THE SITE AND PROMPTLY NOTIFY THE

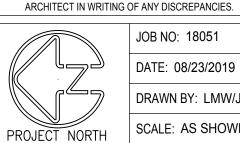

DATE: 08/23/2019 DRAWN BY: LMW/JPR SCALE: AS SHOWN

HISTORIC REHA
530-538 NOR
538 NORTH SALINA ST,

SITE PLAN

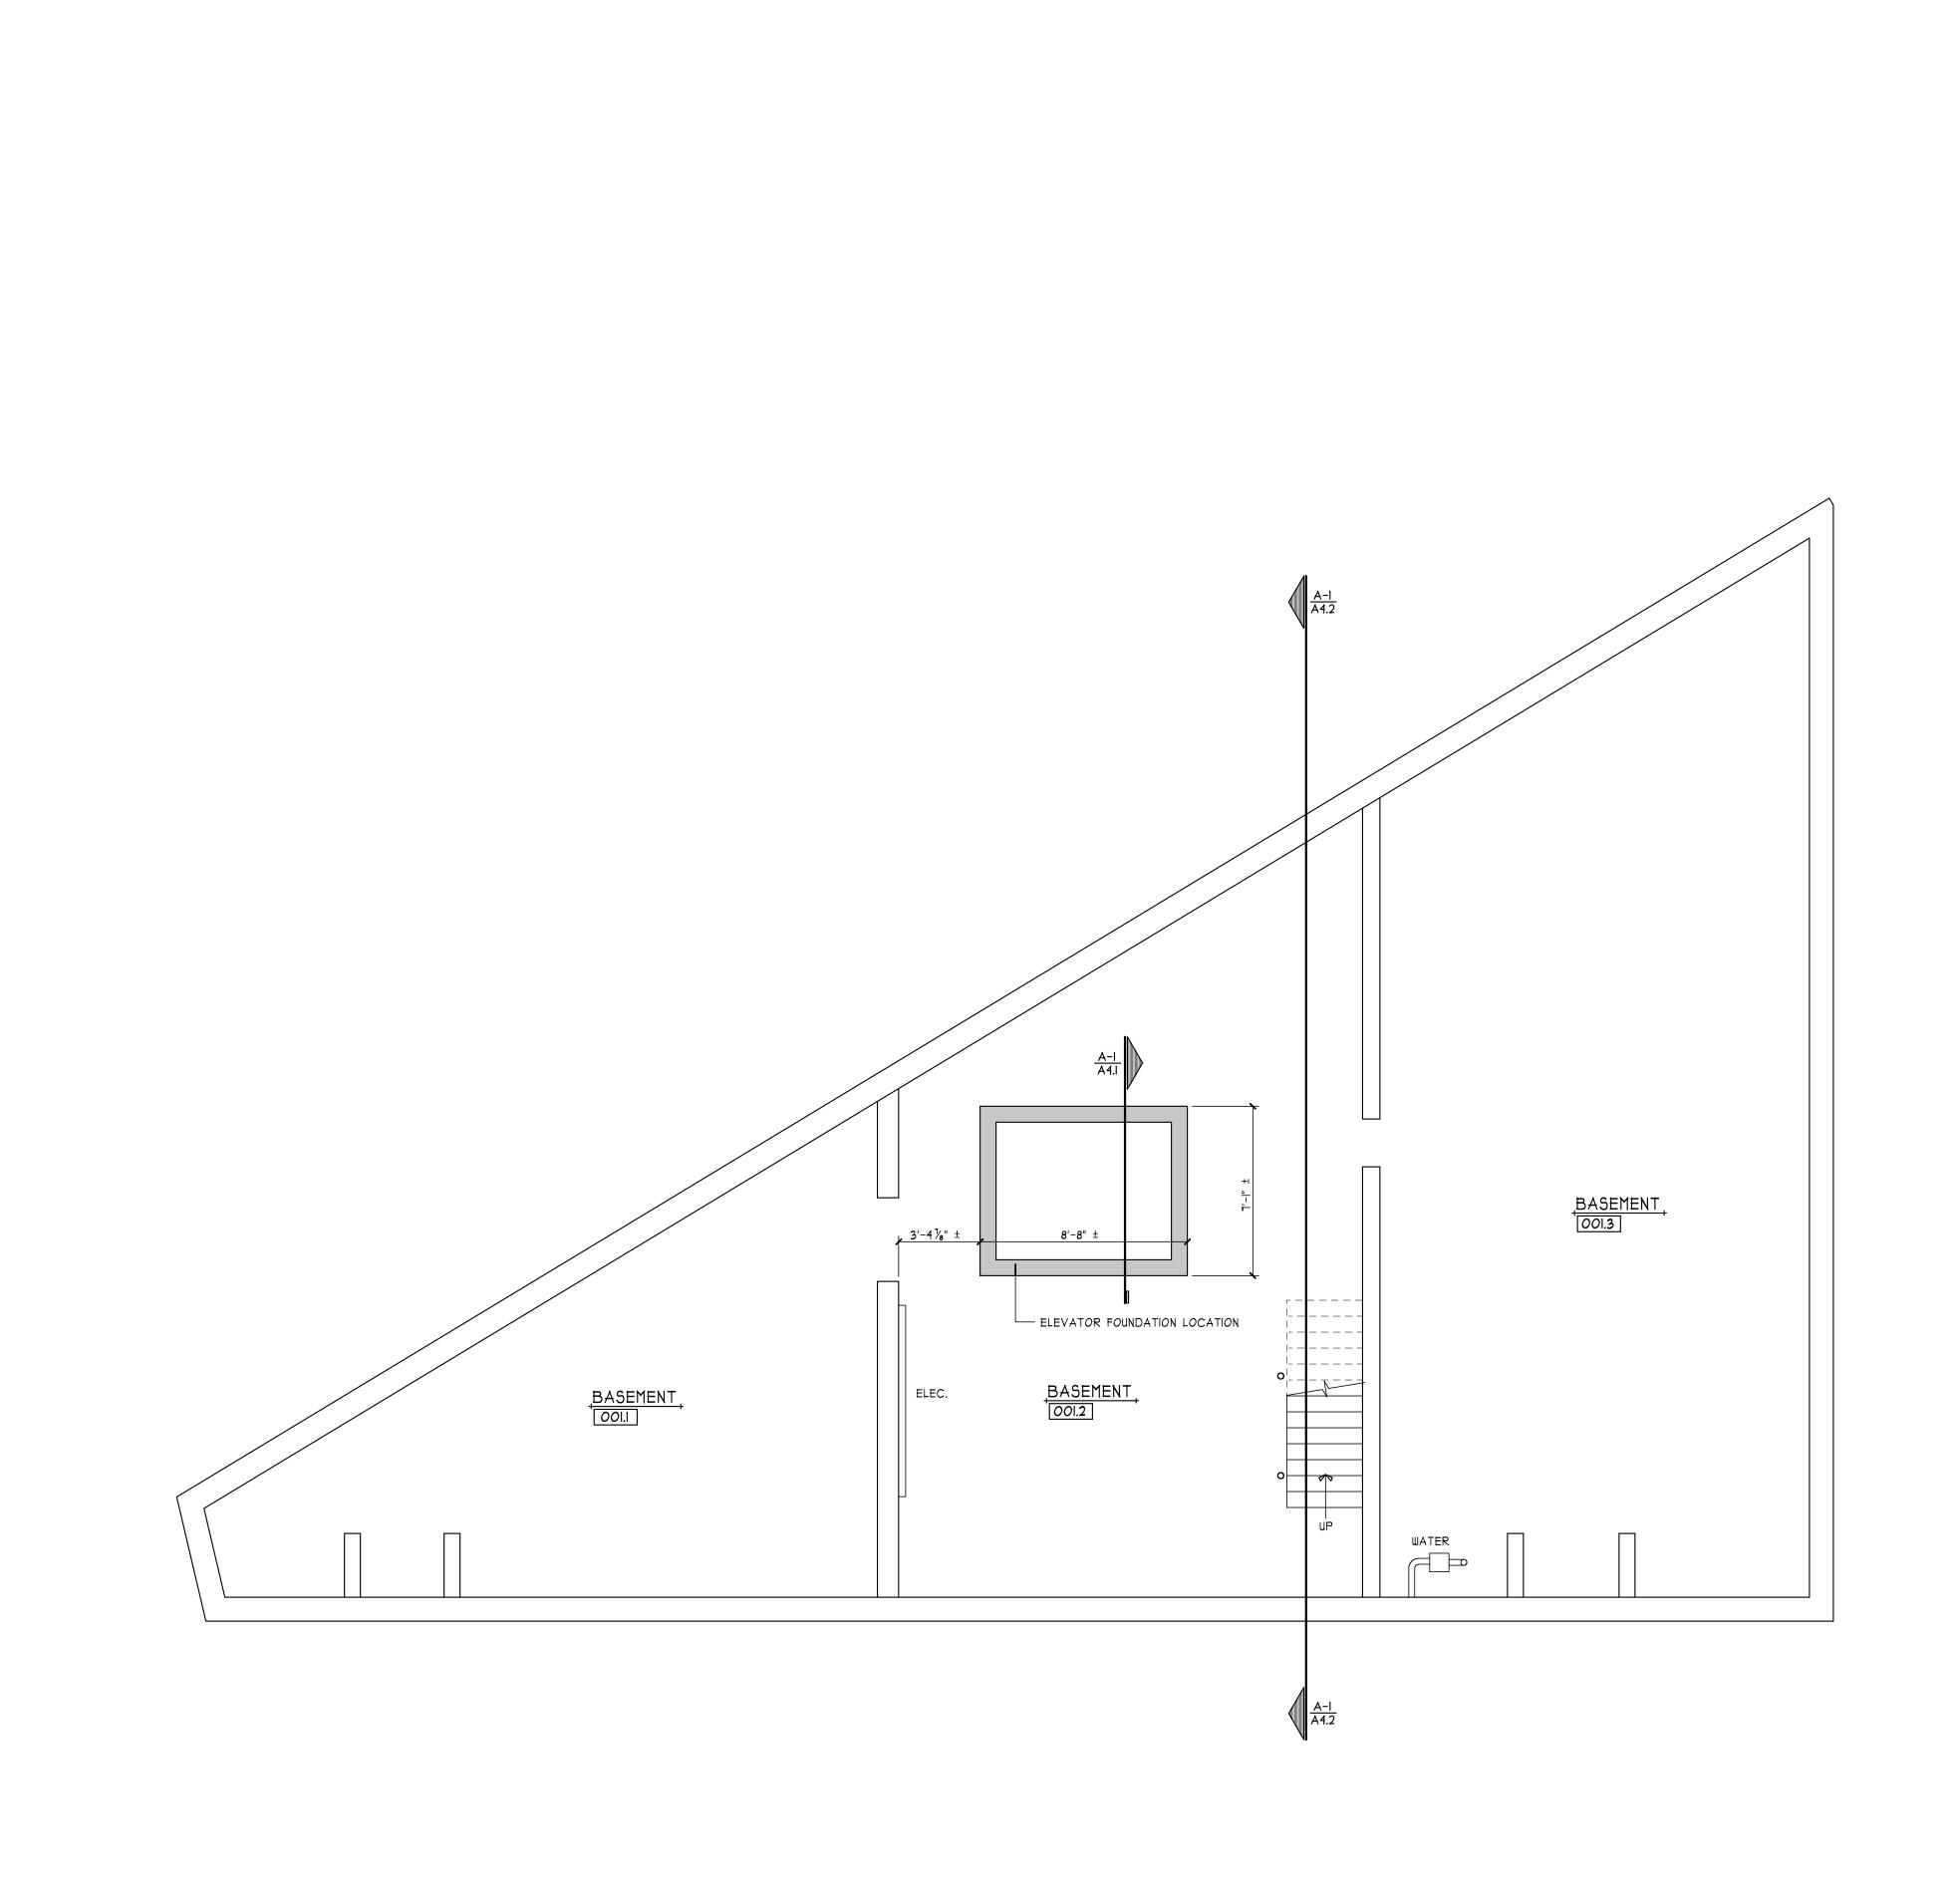


ALL DRAWINGS AND SPECIFICATIONS ARE THE PROPERTY OF THE ARCHITECT, AND SHALL BE USED ONLY ON THE JOB DESIGNATED. COPYRIGHT © THE CONTRACTOR SHALL VERIFY ALL DIMENSIONS AT THE SITE AND PROMPTLY NOTIFY THE ARCHITECT IN WRITING OF ANY DISCREPANCIES.

PROJECT NORTH

JOB NO: 18051 DATE: 08/23/2019 DRAWN BY: CPN SCALE: 1/4" = 1'-0"

HISTORIC 530-536 North sali

BASEMENT FLOOR PLAN

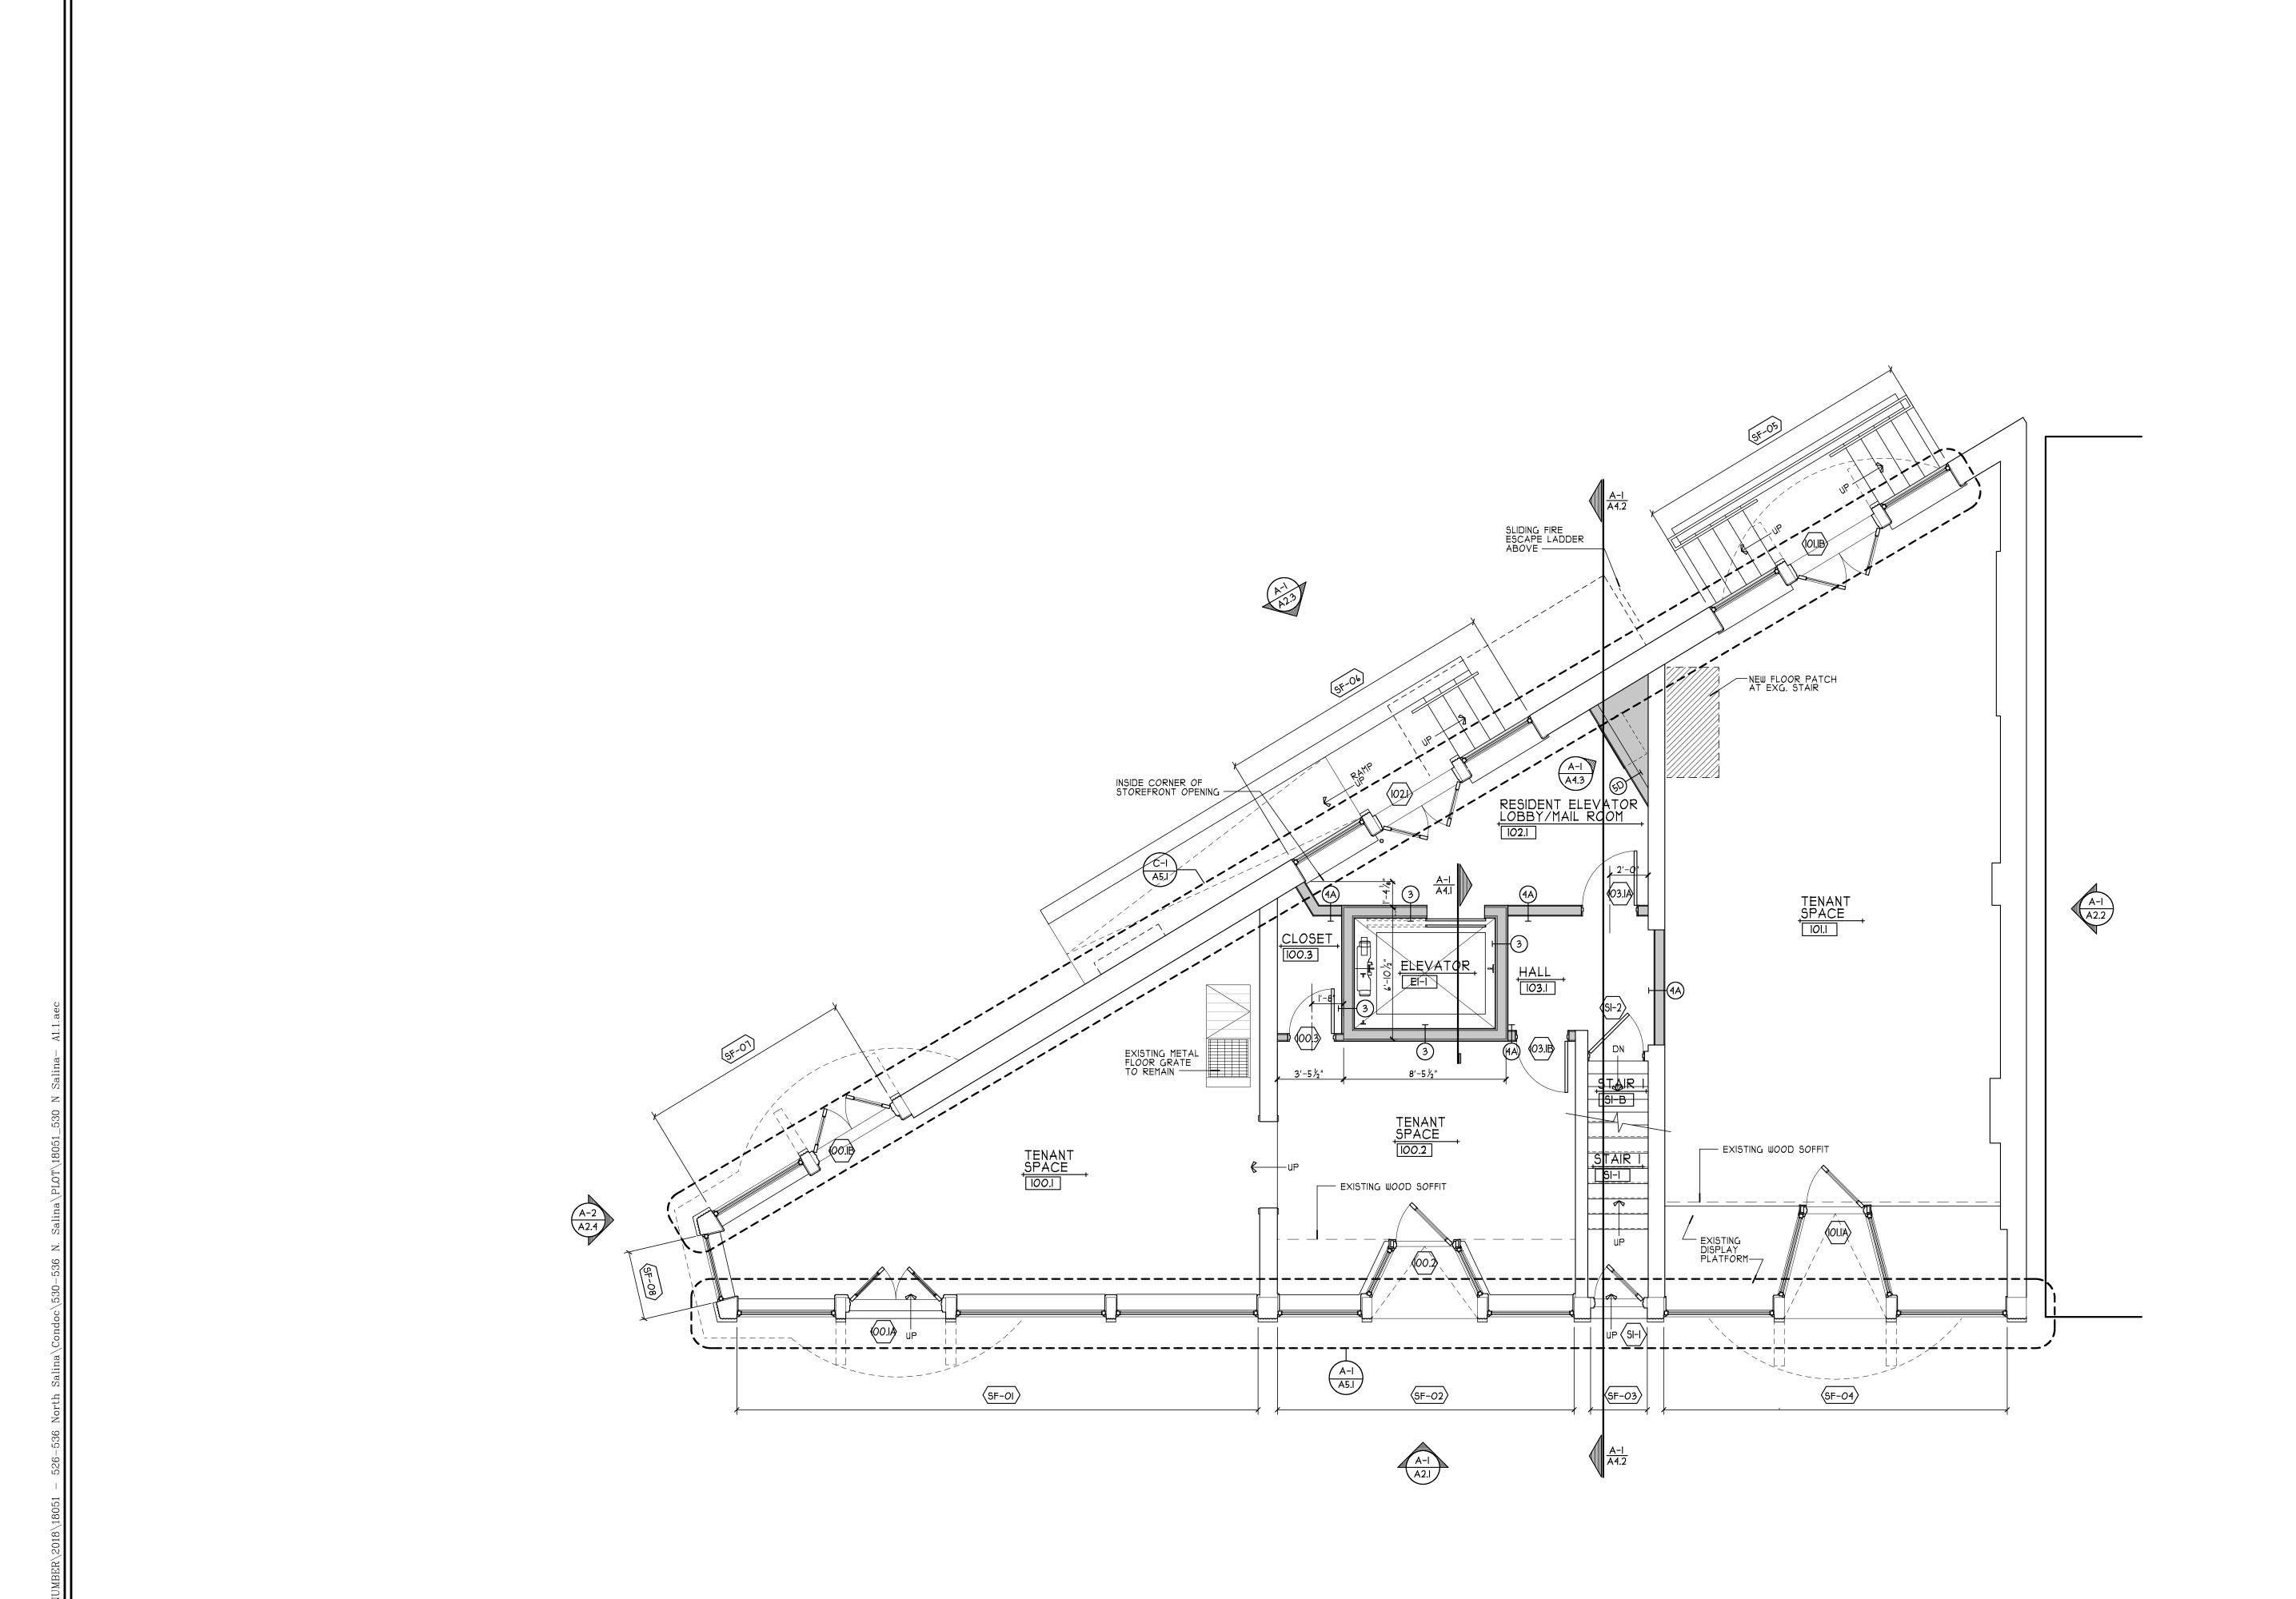


ALL DRAWINGS AND SPECIFICATIONS ARE THE PROPERTY OF THE ARCHITECT, AND SHALL BE USED ONLY ON THE JOB DESIGNATED. COPYRIGHT © THE CONTRACTOR SHALL VERIFY ALL DIMENSIONS AT THE SITE AND PROMPTLY NOTIFY THE ARCHITECT IN WRITING OF ANY DISCREPANCIES.

PROJECT NORTH

DATE: 08/23/2019 DRAWN BY: CPN SCALE: 1/4" = 1'-0"

FIRST FLOOR PLAN

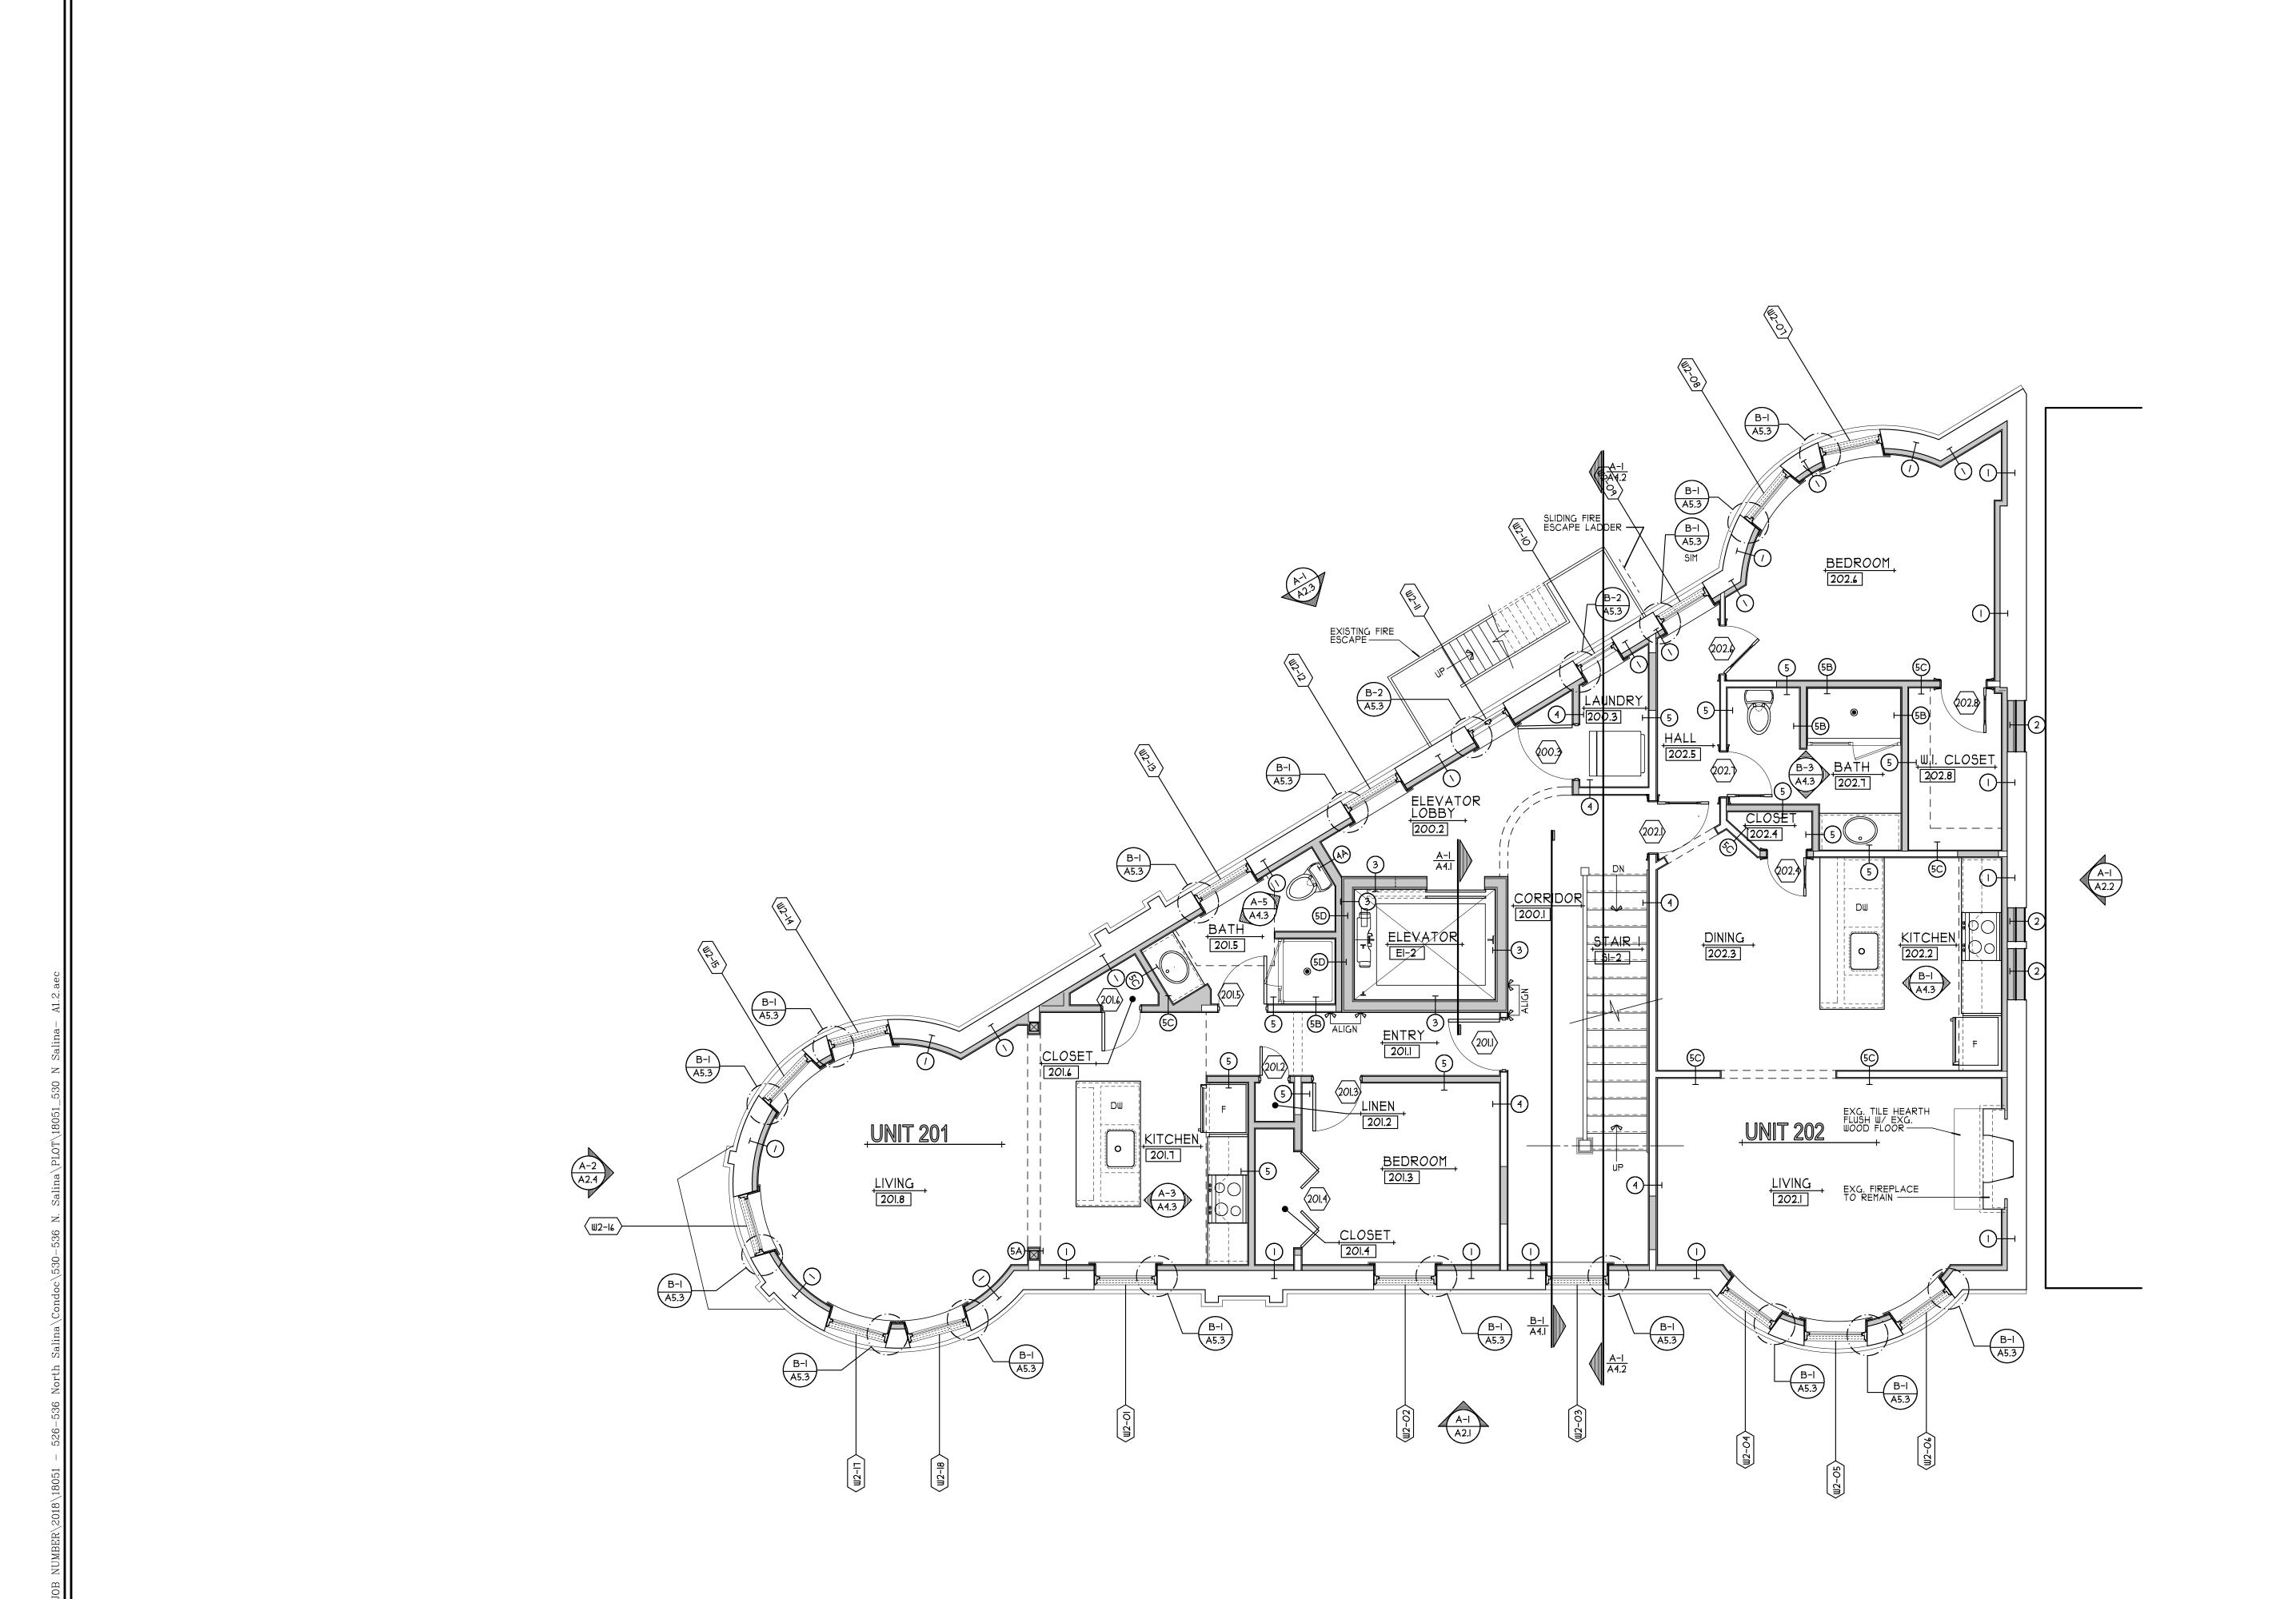

ALL DRAWINGS AND SPECIFICATIONS ARE THE PROPERTY OF THE ARCHITECT, AND SHALL BE USED ONLY ON THE JOB DESIGNATED. COPYRIGHT © THE CONTRACTOR SHALL VERIFY ALL DIMENSIONS AT THE SITE AND PROMPTLY NOTIFY THE ARCHITECT IN WRITING OF ANY DISCREPANCIES.


PROJECT NORTH

DATE: 08/23/2019 DRAWN BY: CPN SCALE: 1/4" = 1'-0"

SECOND FLOOR PLAN

HISTOR 530-536 -- 536 NORTH SA

SECOND FLOOR PLAN
SCALE: 1/4" = 1'-0" + A-1
A1.2

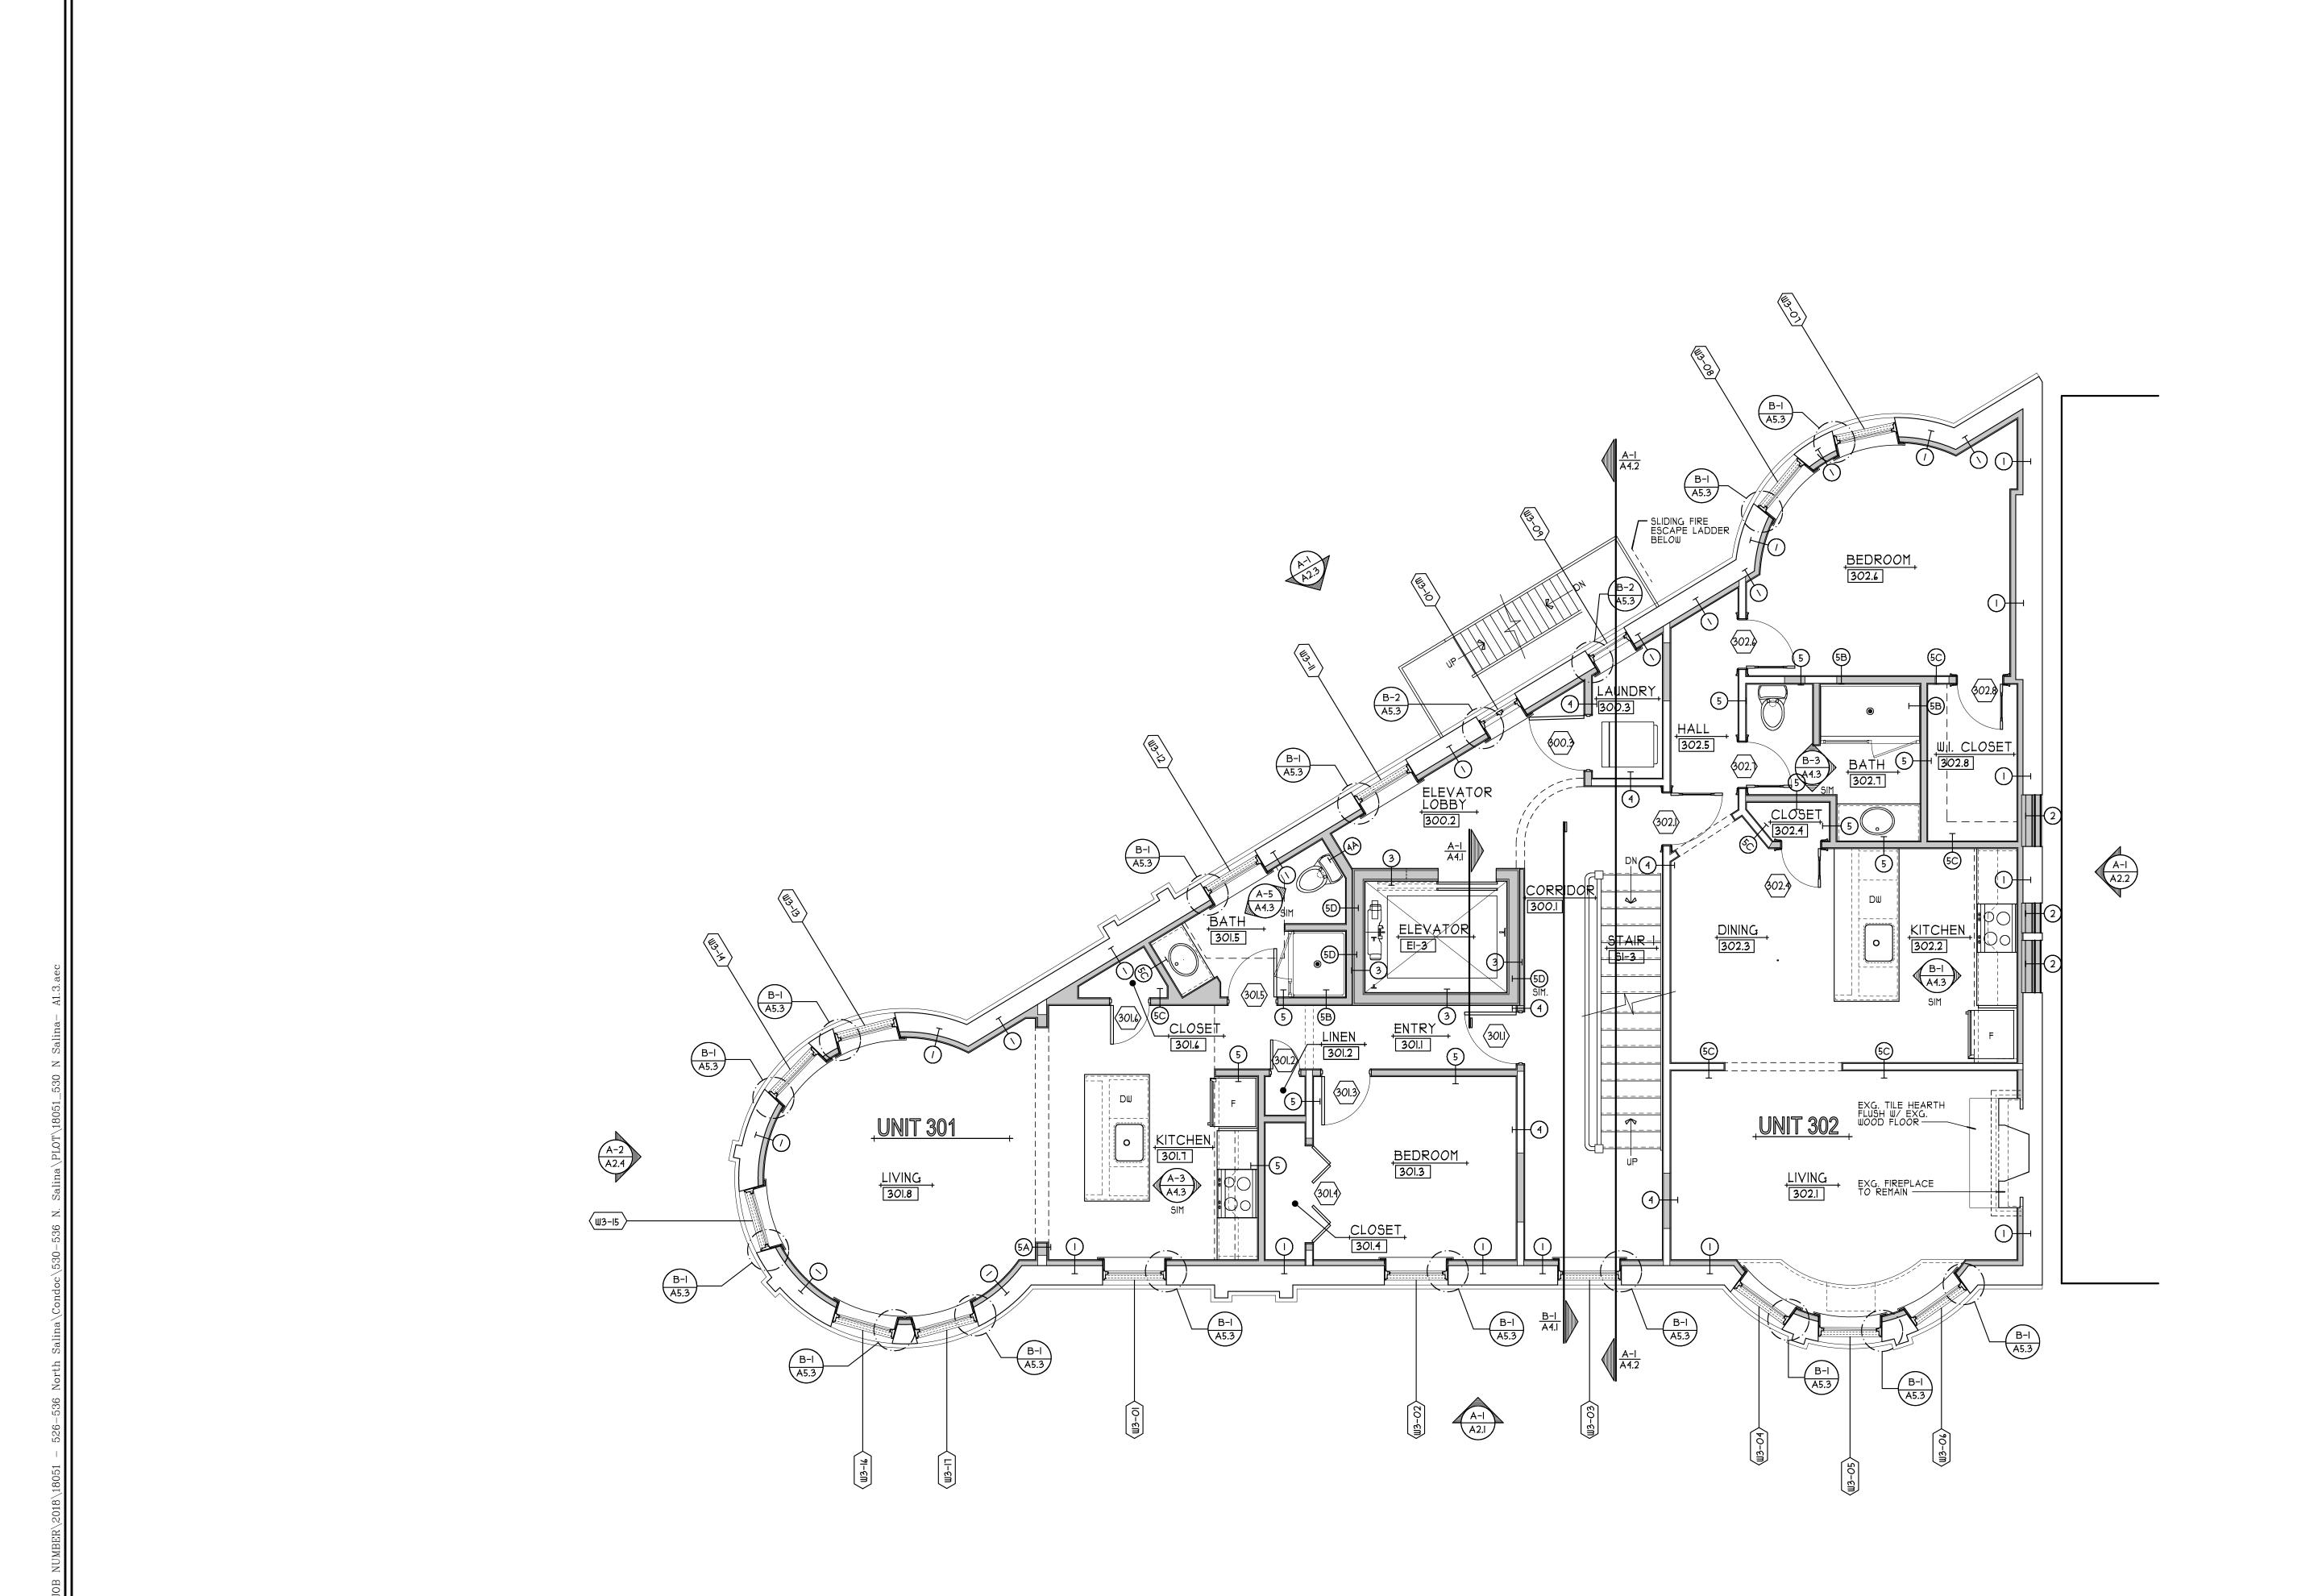

ALL DRAWINGS AND SPECIFICATIONS ARE THE PROPERTY OF THE ARCHITECT, AND SHALL BE USED ONLY ON THE JOB DESIGNATED. COPYRIGHT © THE CONTRACTOR SHALL VERIFY ALL DIMENSIONS AT THE SITE AND PROMPTLY NOTIFY THE ARCHITECT IN WRITING OF ANY DISCREPANCIES.


PROJECT NORTH

DRAWN BY: CPN

DATE: 08/23/2019 SCALE: 1/4" = 1'-0"

HISTOR 530-536 -536 NORTH SA

THIRD FLOOR PLAN

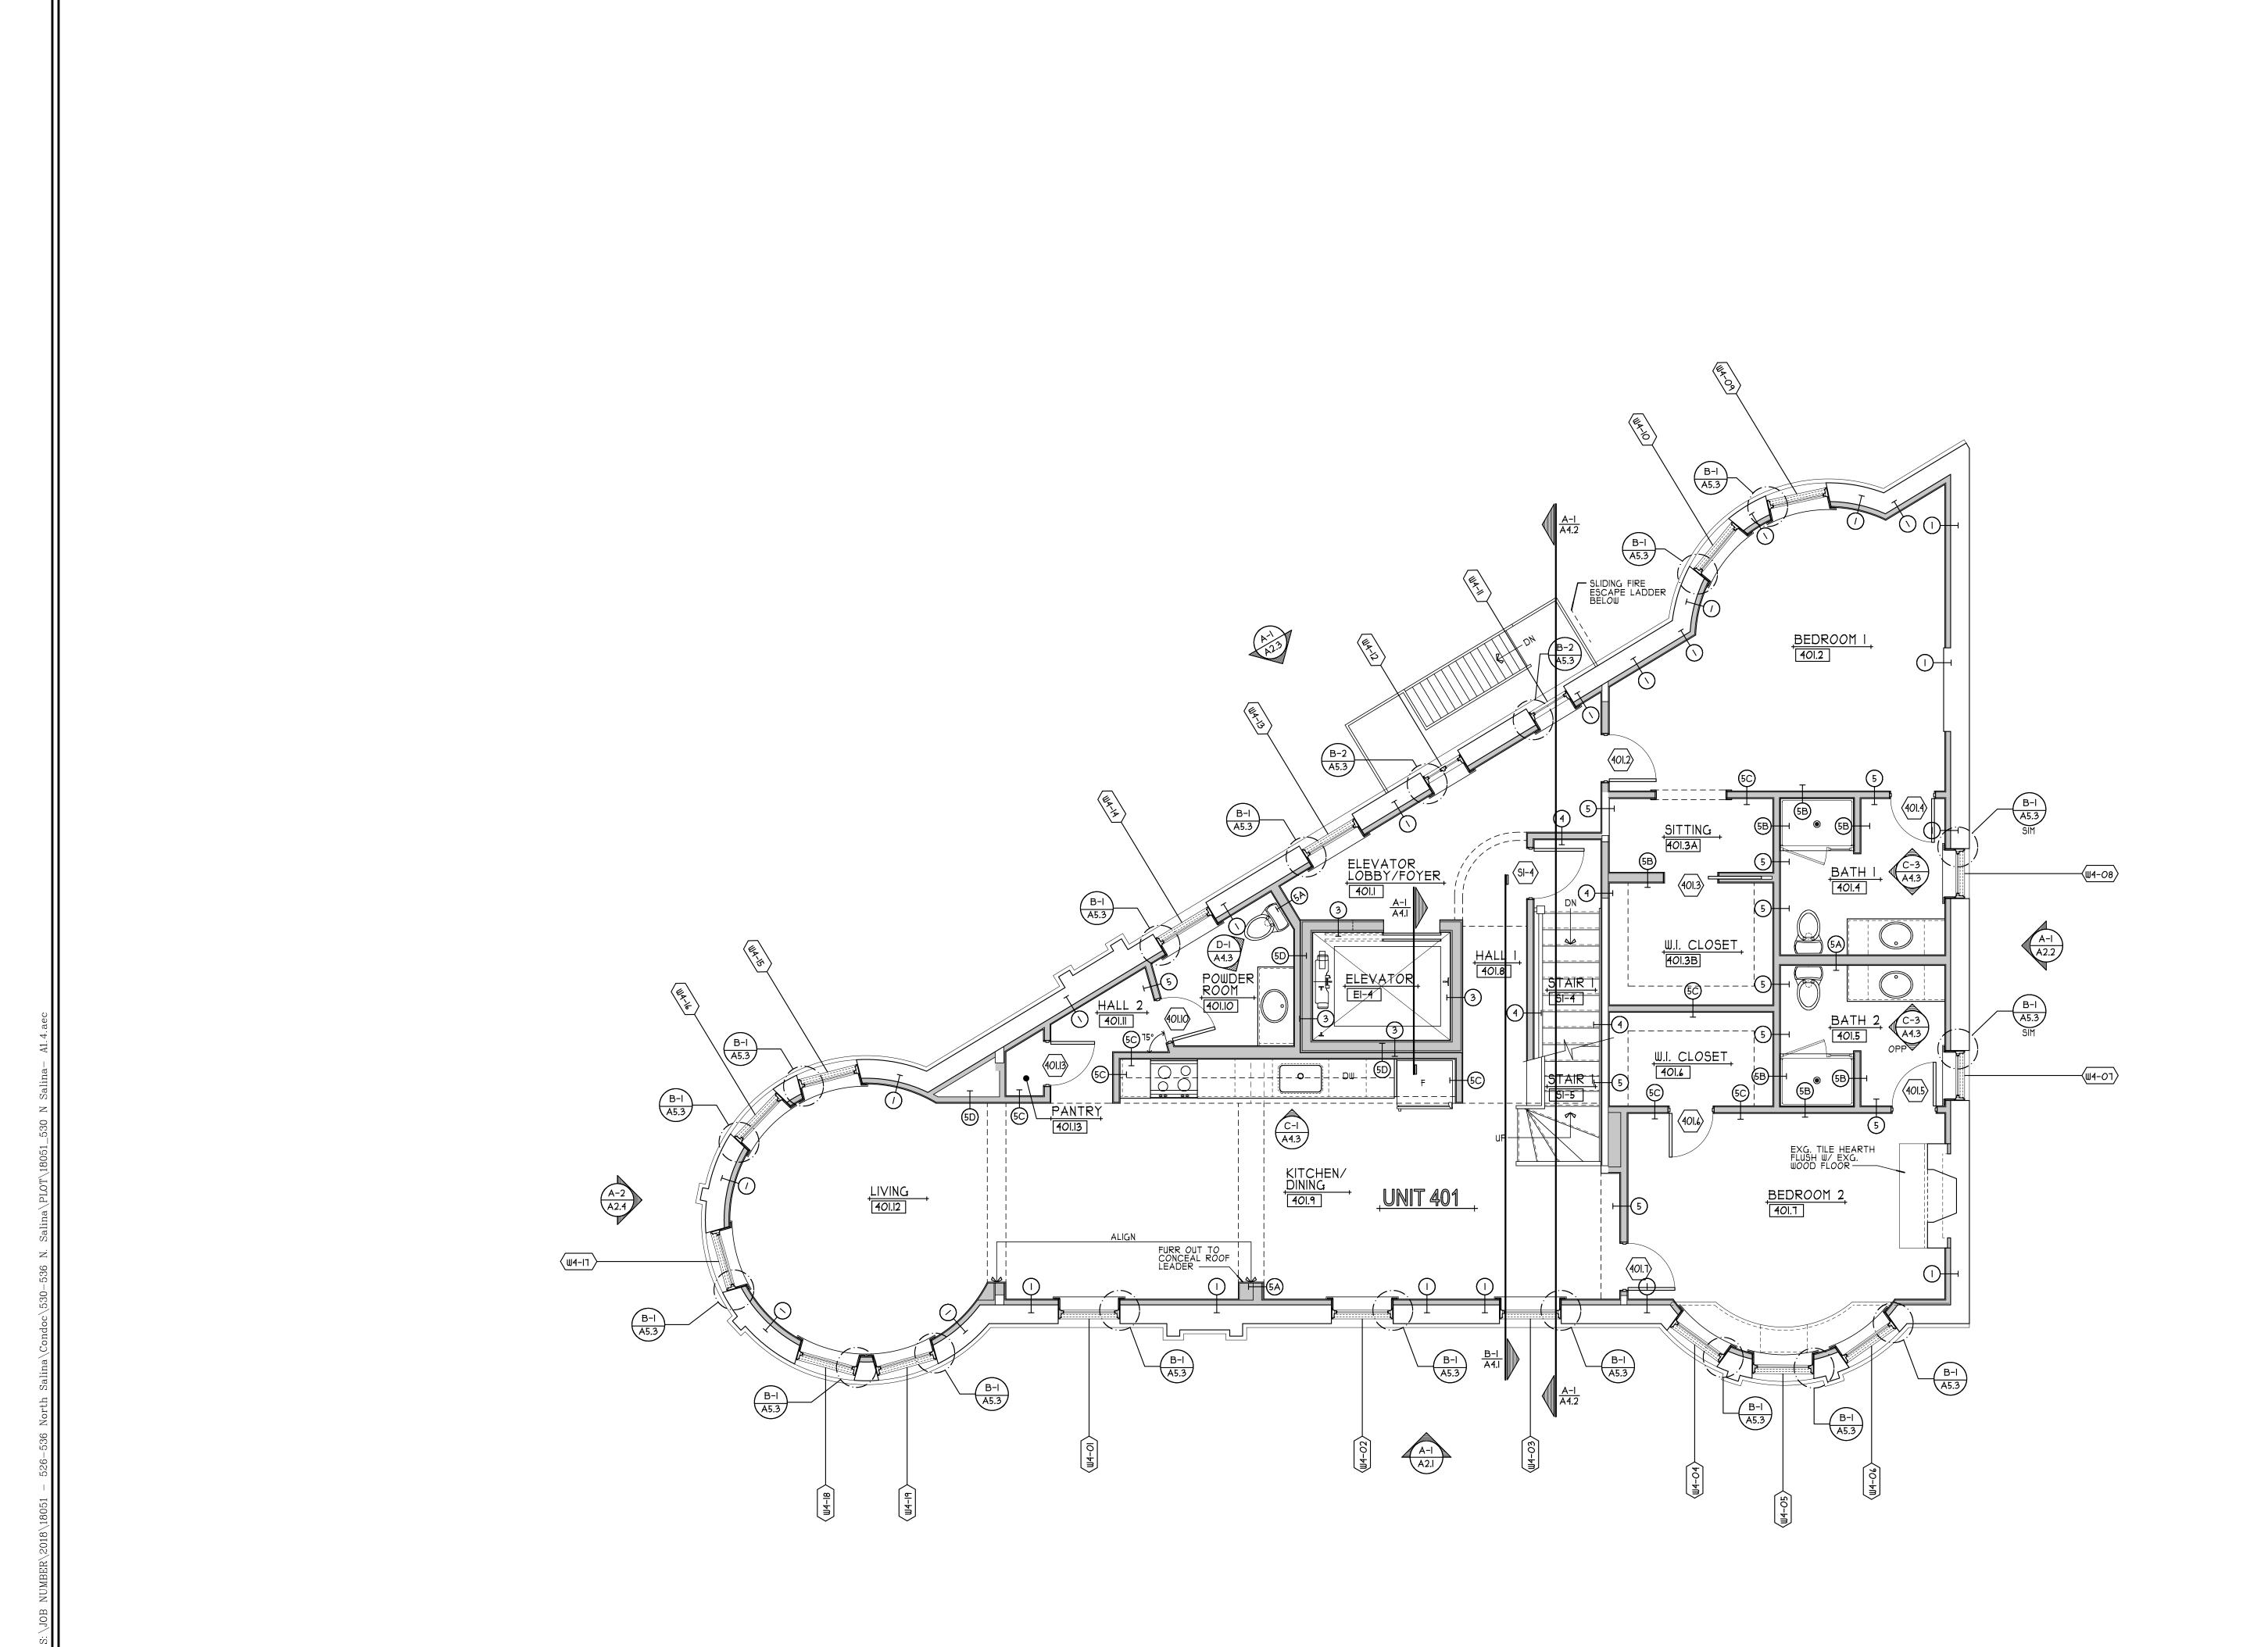


ALL DRAWINGS AND SPECIFICATIONS ARE THE PROPERTY OF THE ARCHITECT, AND SHALL BE USED ONLY ON THE JOB DESIGNATED. COPYRIGHT © THE CONTRACTOR SHALL VERIFY ALL DIMENSIONS AT THE SITE AND PROMPTLY NOTIFY THE ARCHITECT IN WRITING OF ANY DISCREPANCIES.

PROJECT NORTH

DATE: 08/23/2019 DRAWN BY: CPN SCALE: 1/4" = 1'-0"

FOURTH FLOOR PLAN

HIST 530-5.

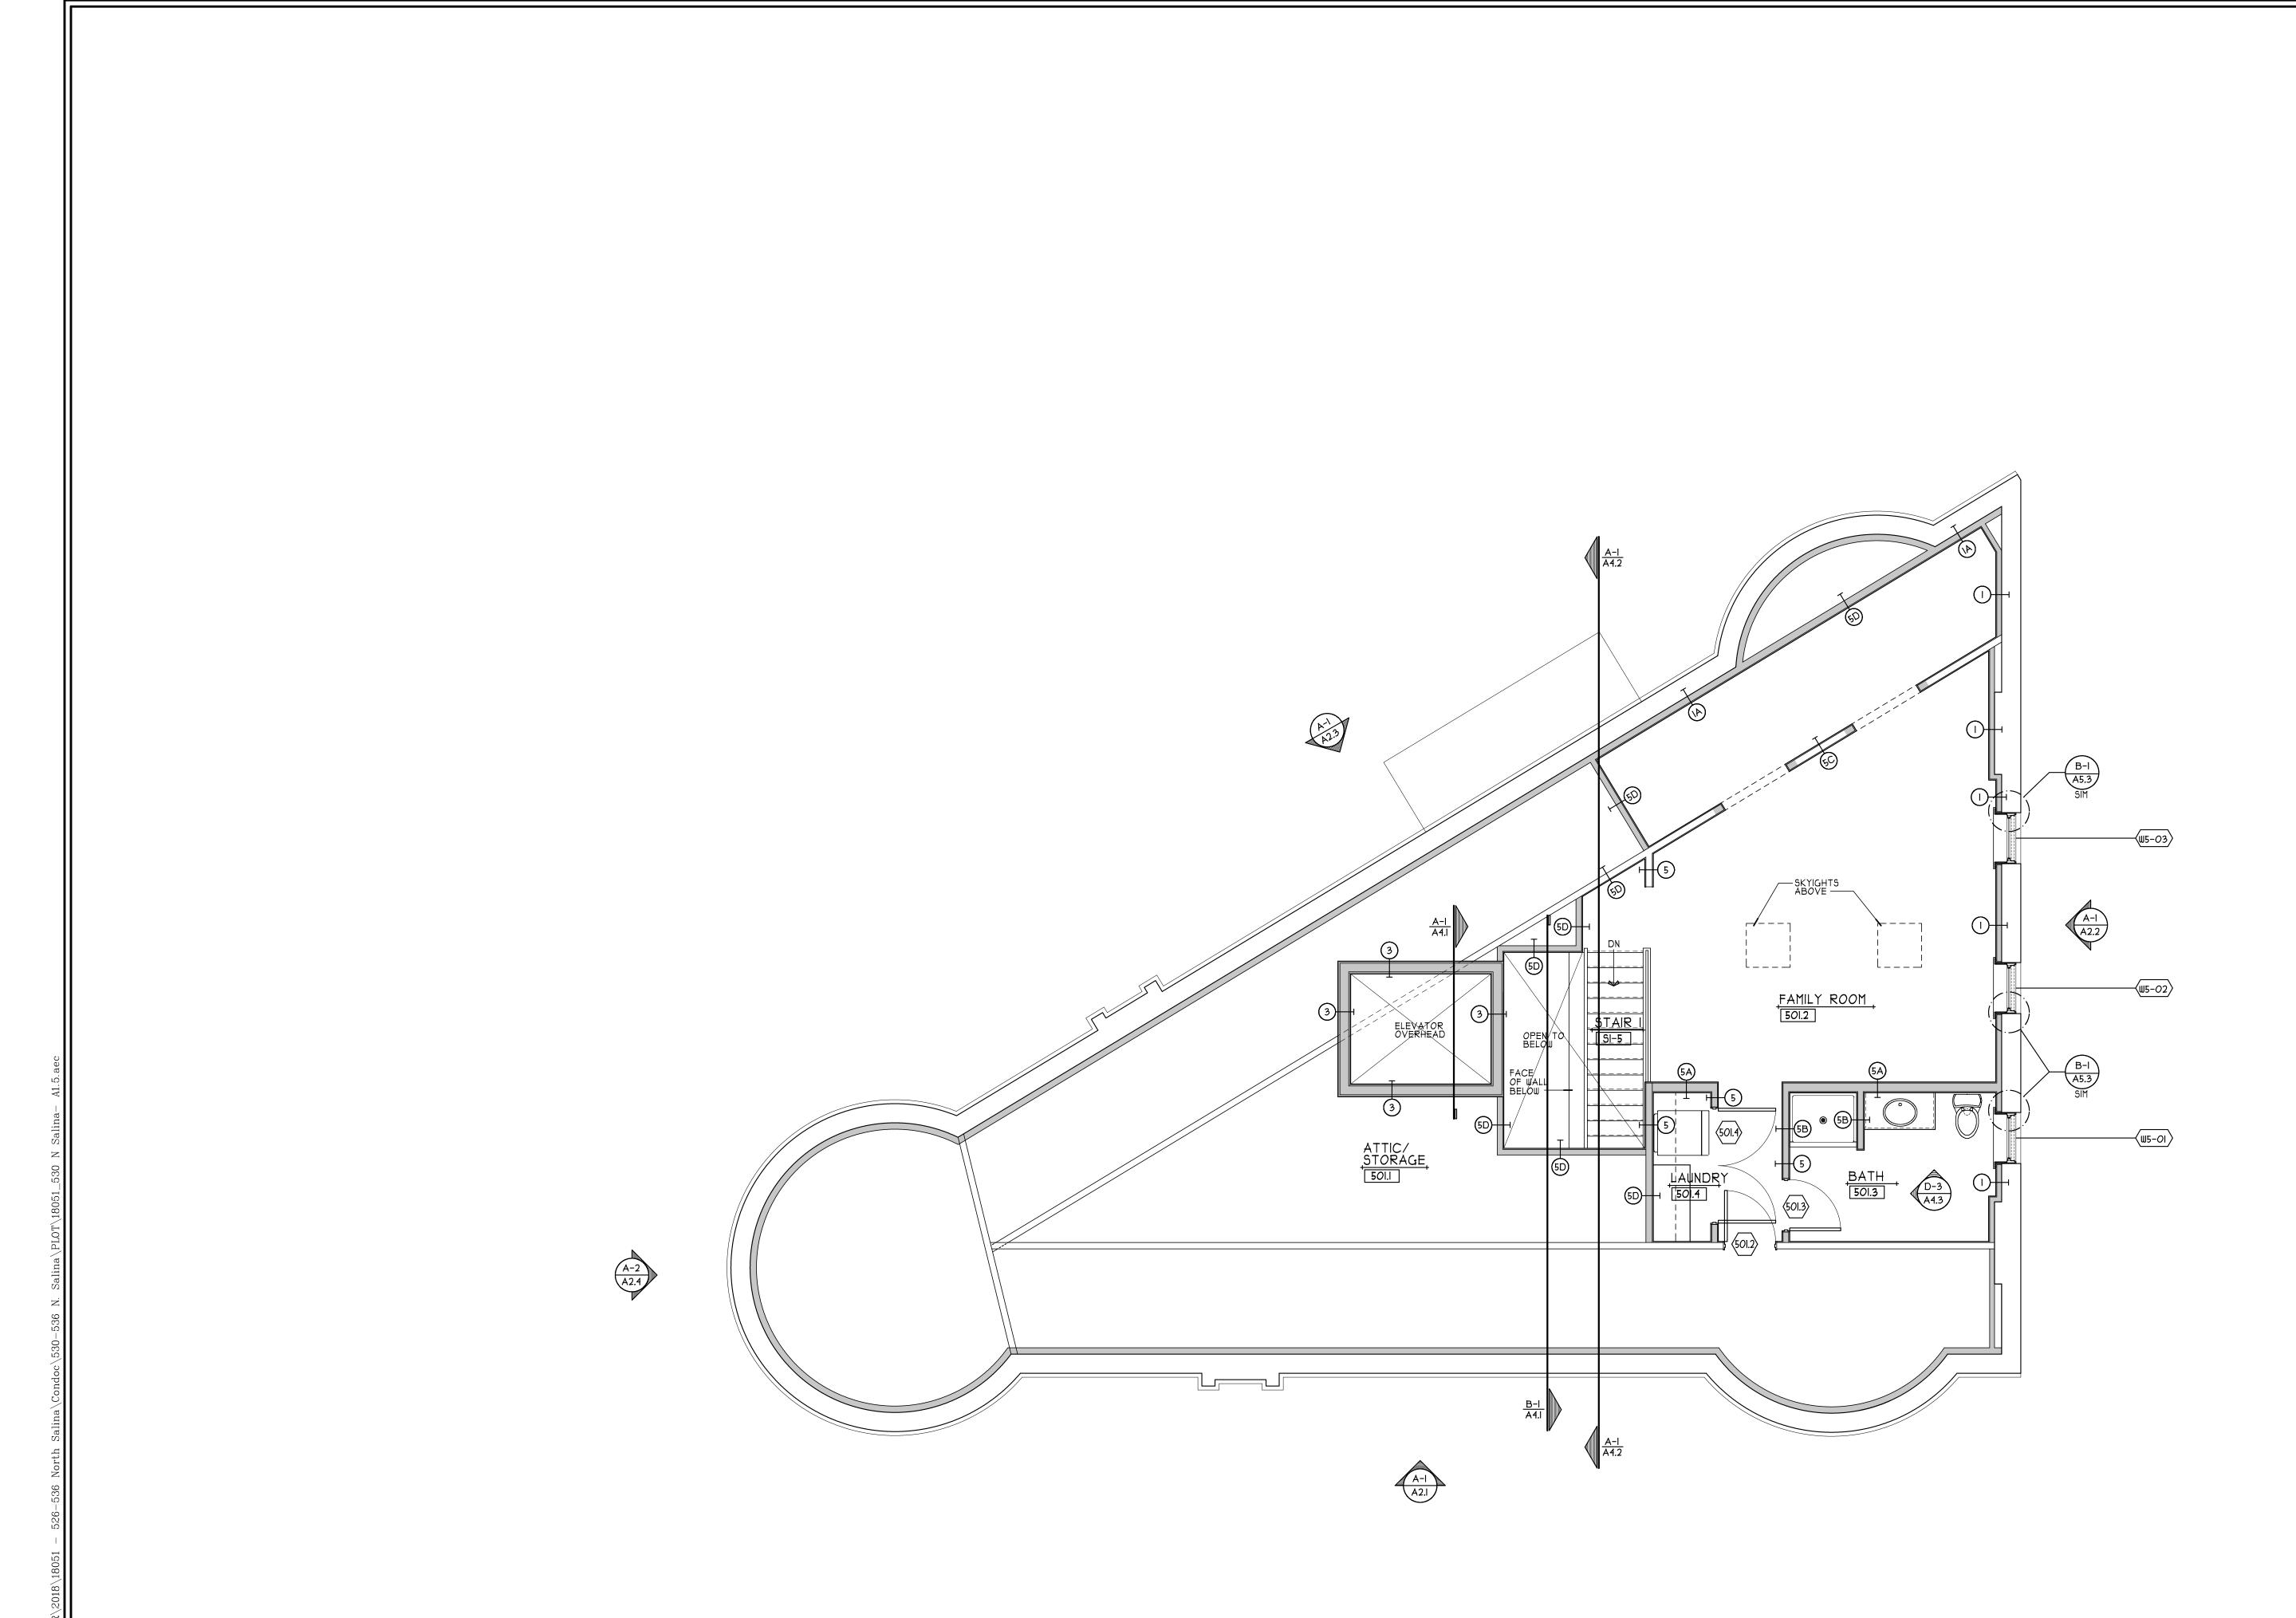


ALL DRAWINGS AND SPECIFICATIONS ARE THE PROPERTY OF THE ARCHITECT, AND SHALL BE USED ONLY ON THE JOB DESIGNATED. COPYRIGHT © THE CONTRACTOR SHALL VERIFY ALL DIMENSIONS AT THE SITE AND PROMPTLY NOTIFY THE ARCHITECT IN WRITING OF ANY DISCREPANCIES.

PROJECT NORTH

DATE: 08/23/2019 DRAWN BY: CPN SCALE: 1/4" = 1'-0"

ATTIC FLOOR PLAN

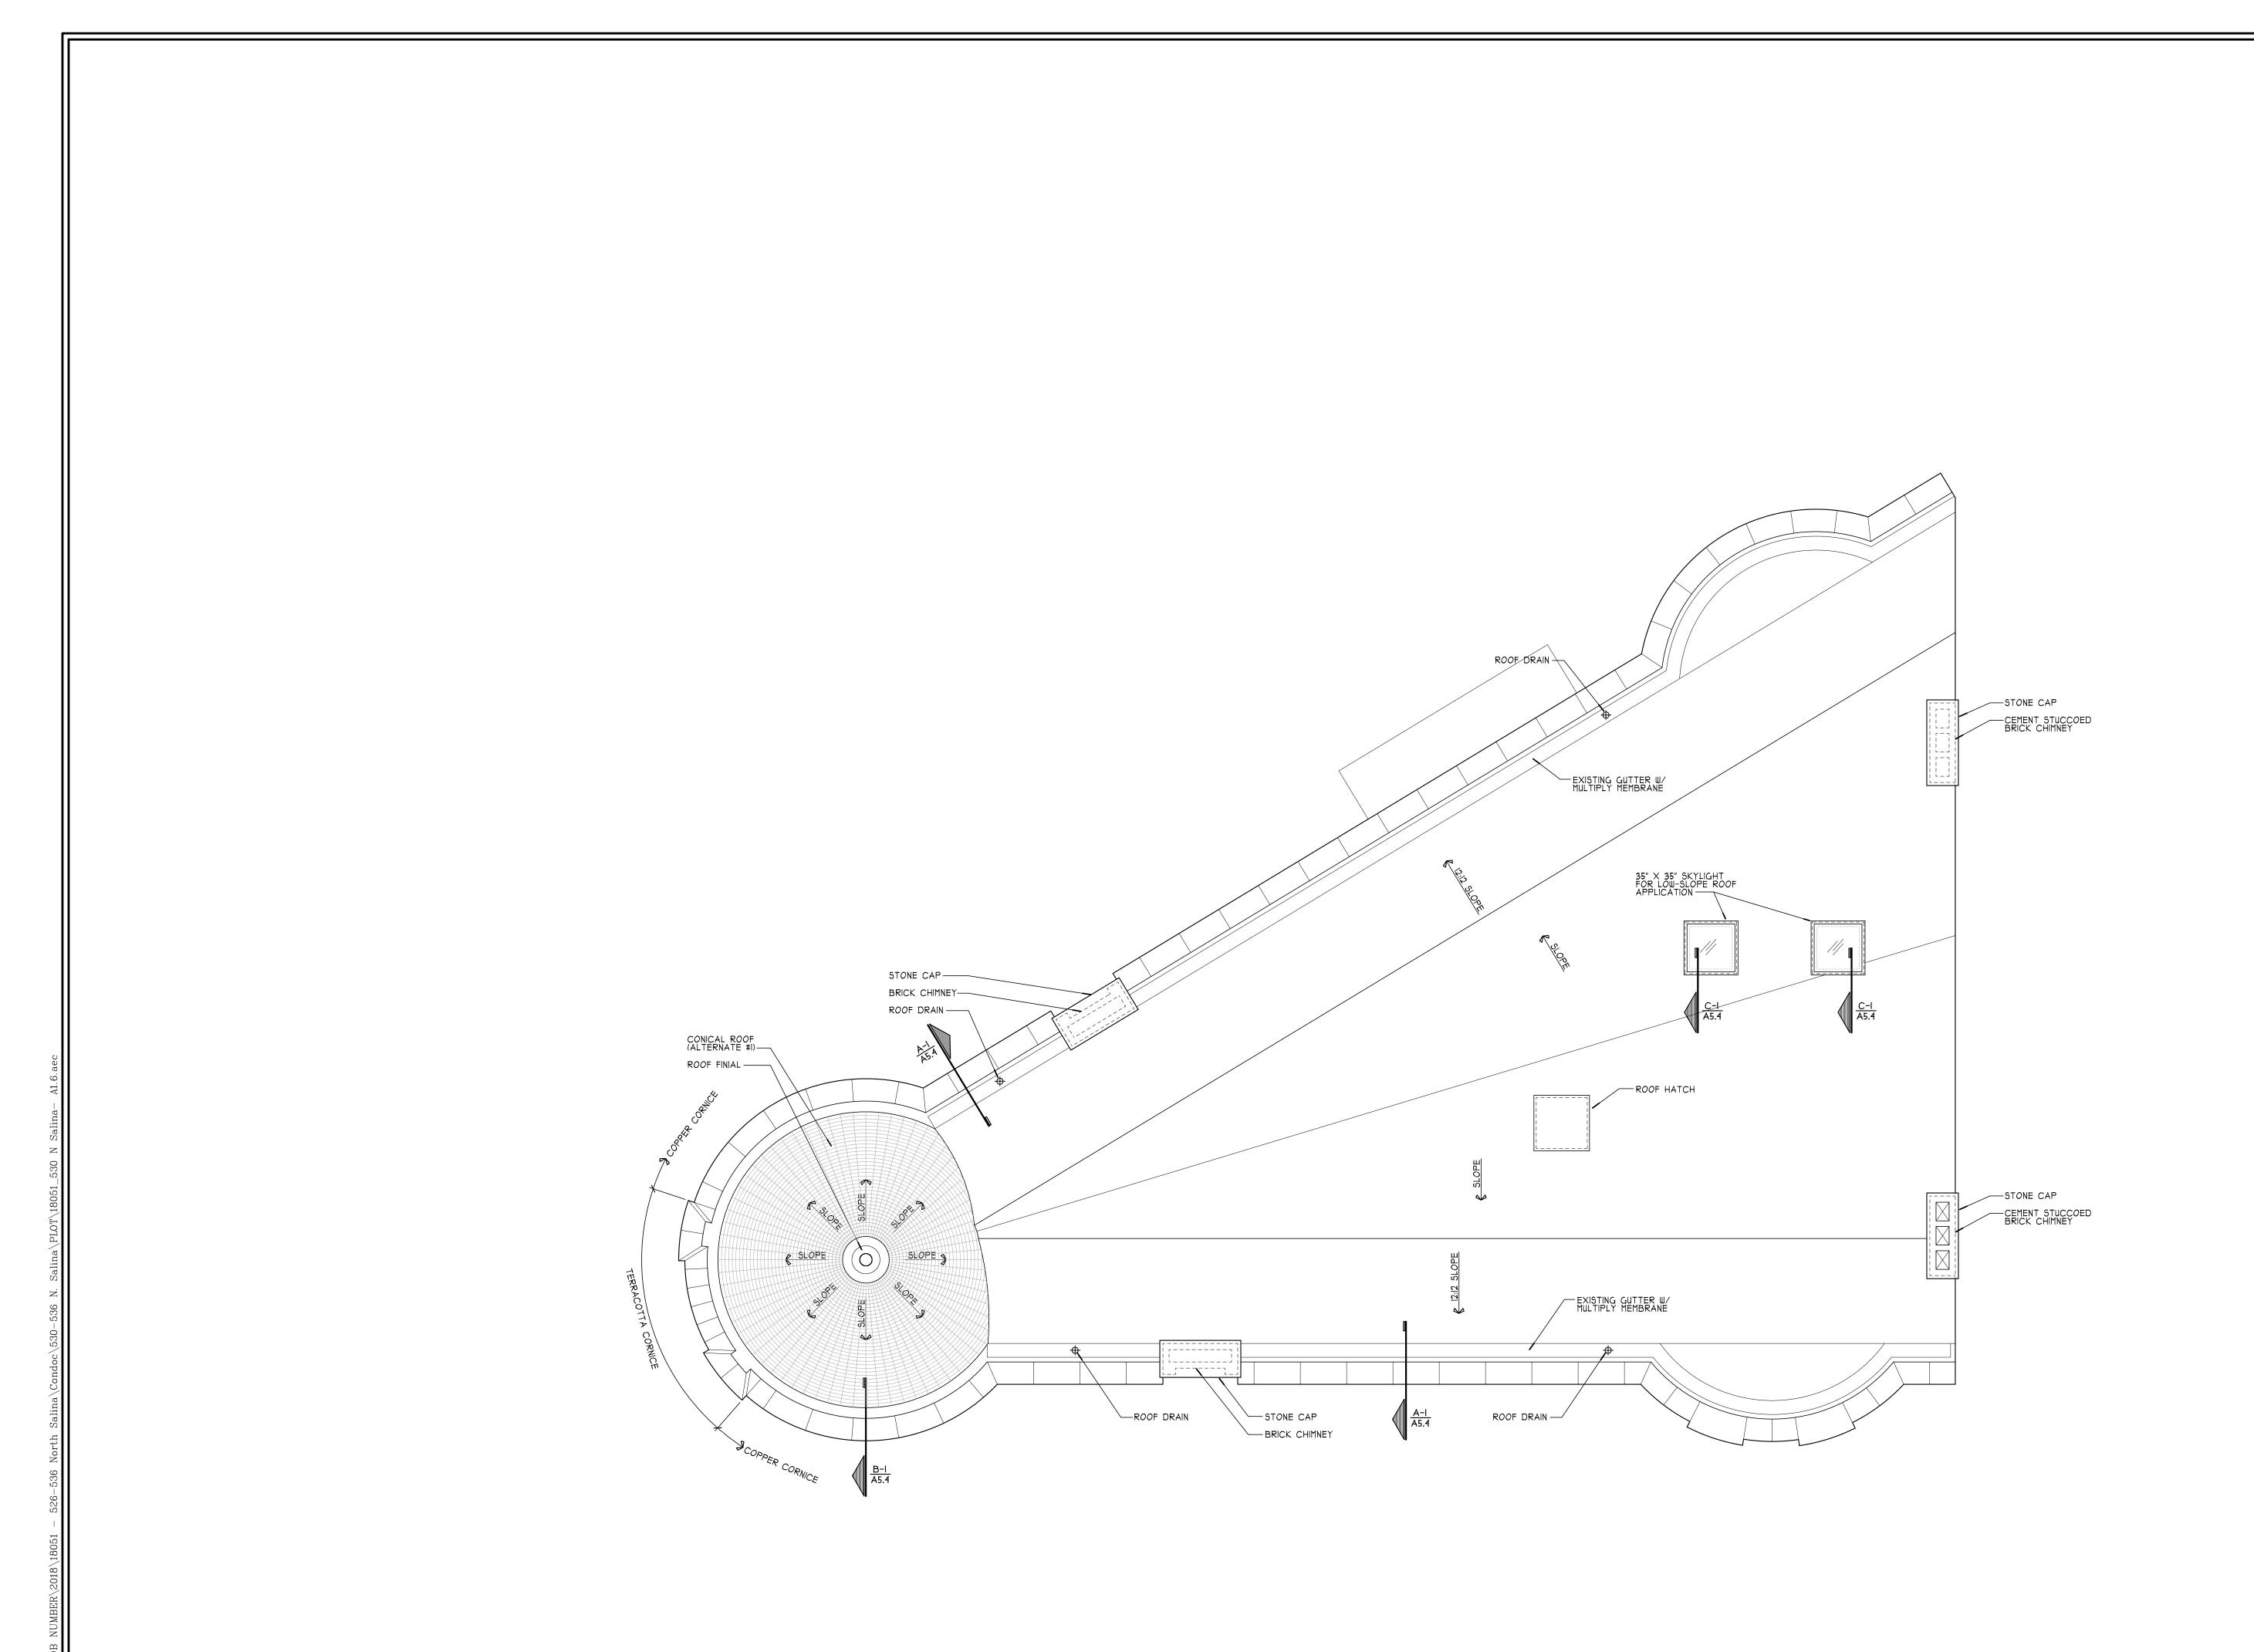


ALL DRAWINGS AND SPECIFICATIONS ARE THE PROPERTY OF THE ARCHITECT, AND SHALL BE USED ONLY ON THE JOB DESIGNATED. COPYRIGHT © THE CONTRACTOR SHALL VERIFY ALL DIMENSIONS AT THE SITE AND PROMPTLY NOTIFY THE ARCHITECT IN WRITING OF ANY DISCREPANCIES.



JOB NO: 18051 DATE: 08/23/2019 DRAWN BY: CPN

SCALE: 1/4" = 1'-0"

ROOF PLAN

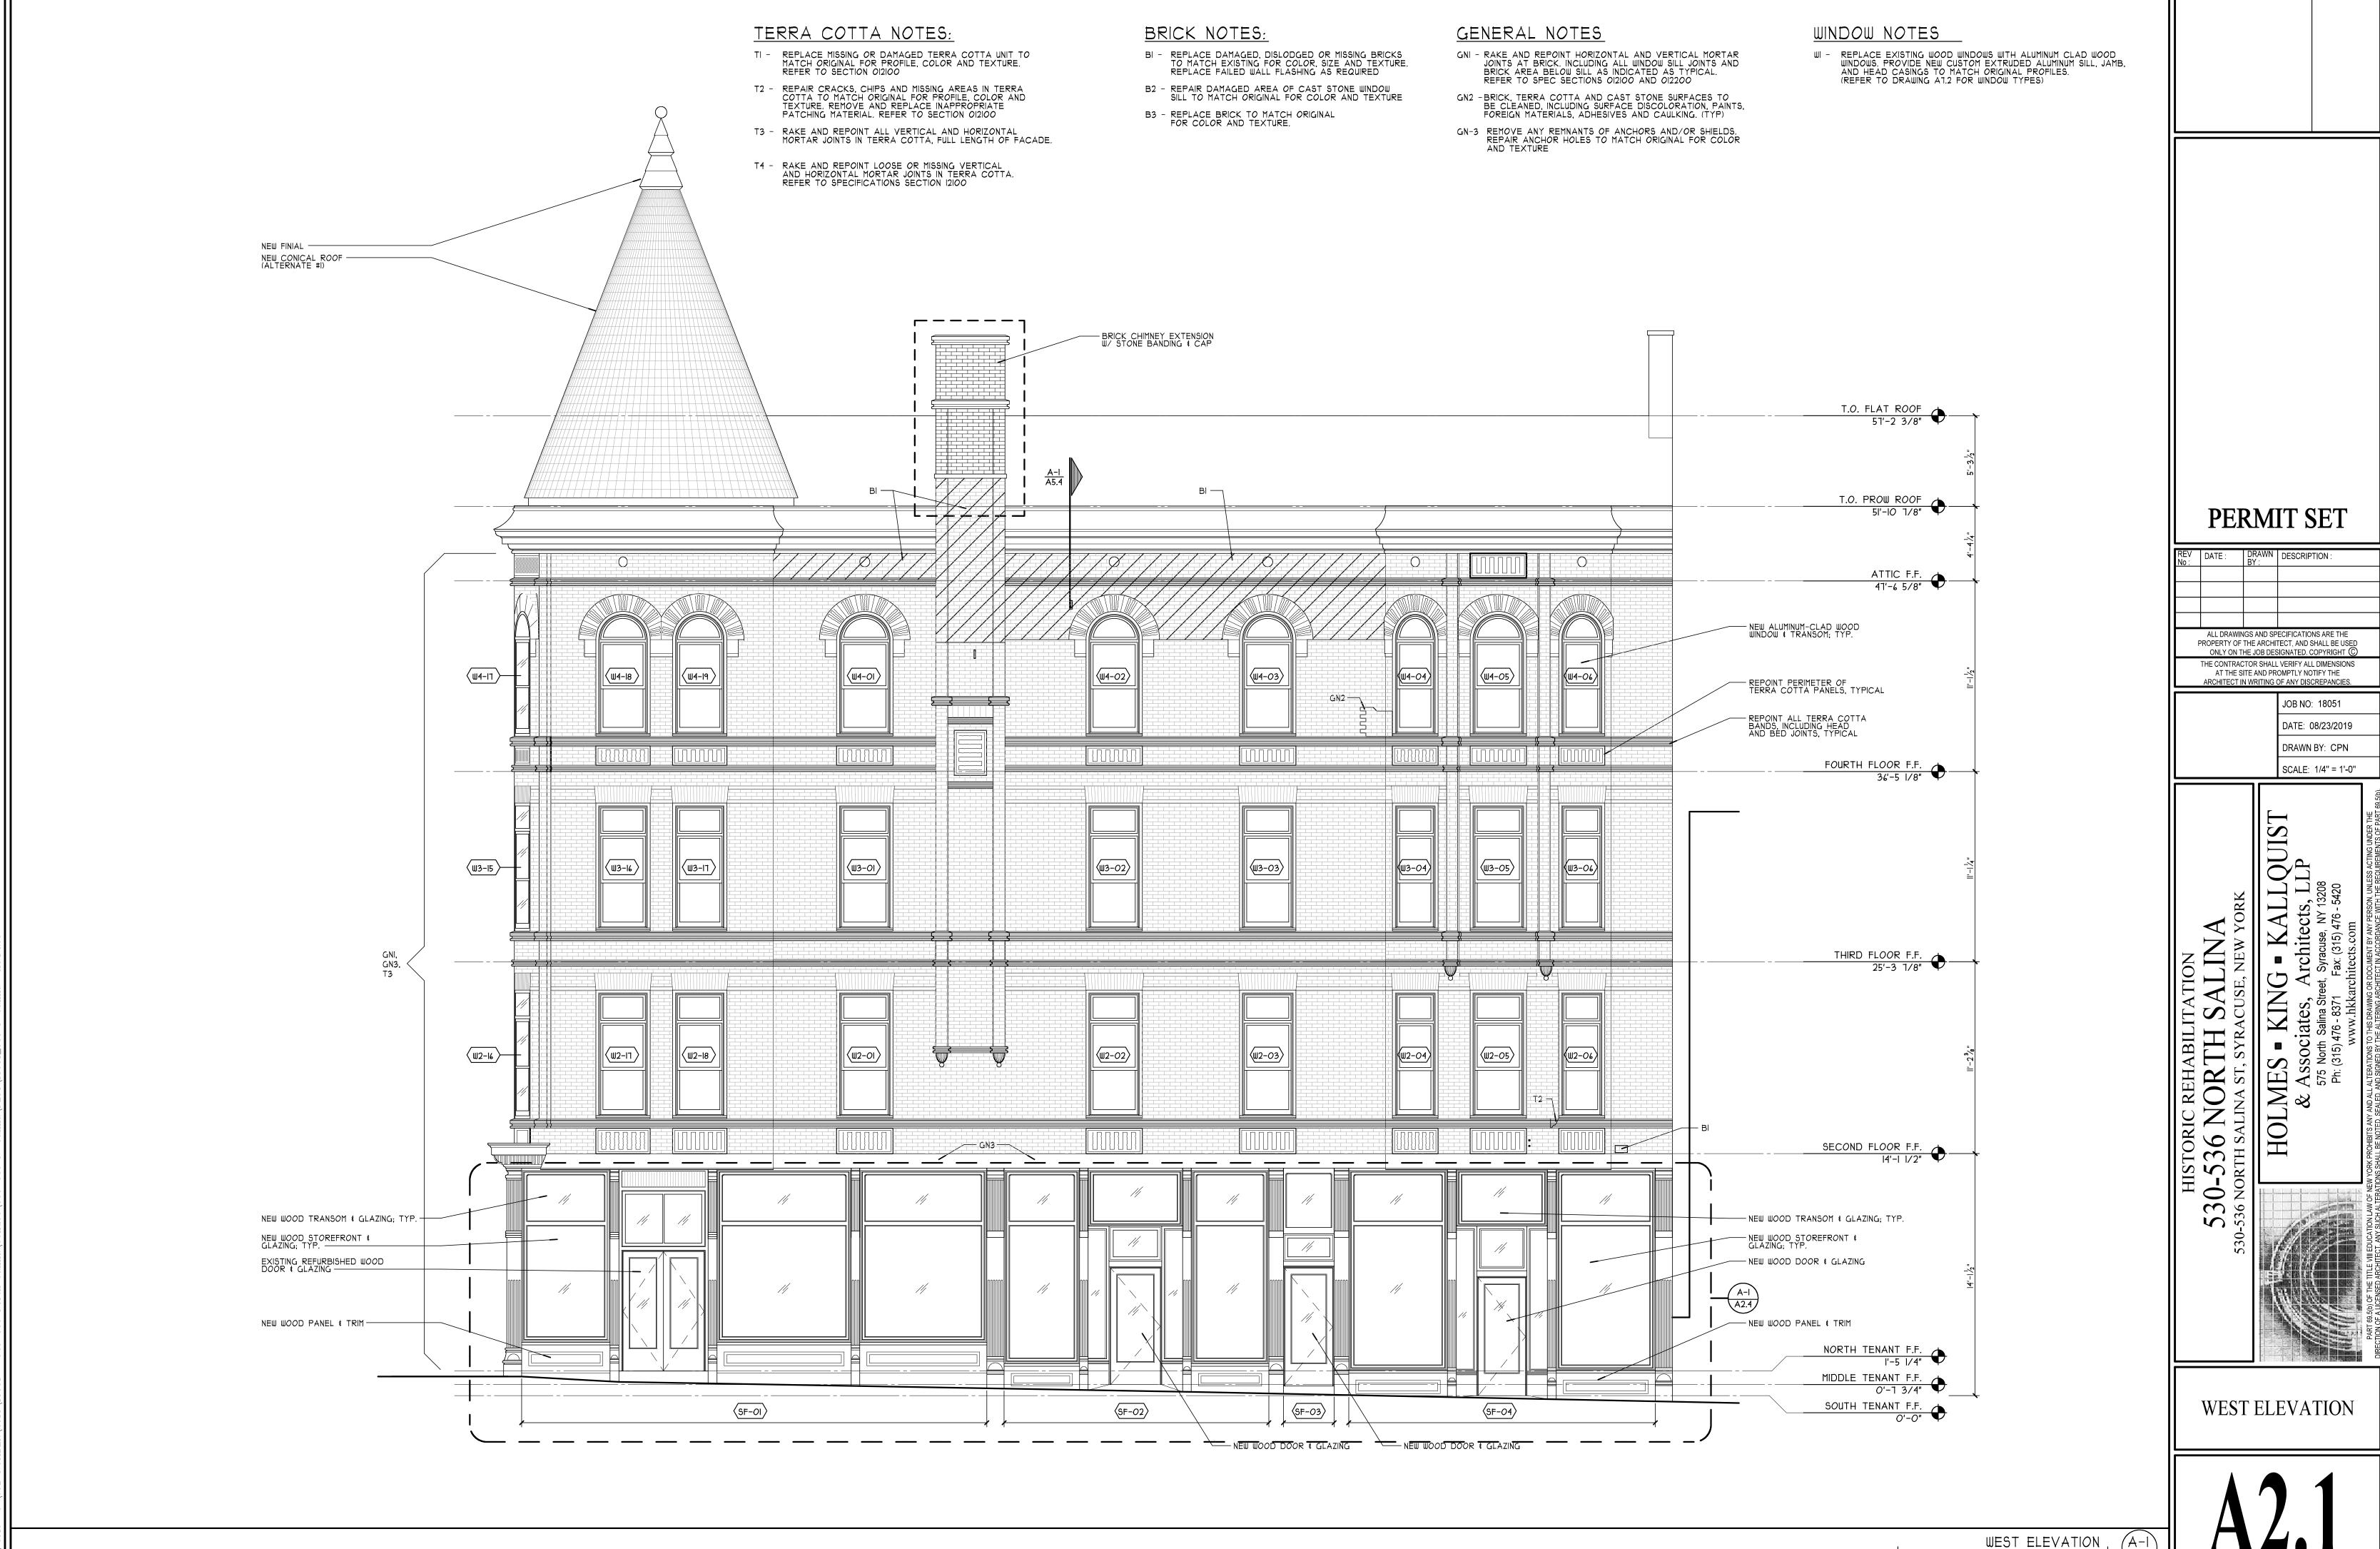

 $\frac{\text{WEST ELEVATION}}{\text{SCALE}: 1/4" = 1'-0"} + \frac{A-1}{A2.1}$




ALL DRAWINGS AND SPECIFICATIONS ARE THE PROPERTY OF THE ARCHITECT, AND SHALL BE USED ONLY ON THE JOB DESIGNATED. COPYRIGHT © THE CONTRACTOR SHALL VERIFY ALL DIMENSIONS AT THE SITE AND PROMPTLY NOTIFY THE ARCHITECT IN WRITING OF ANY DISCREPANCIES.

JOB NO: 18051 DATE: 08/23/2019 DRAWN BY: CPN

SCALE: 1/4" = 1'-0"

SOUTH ELEVATION



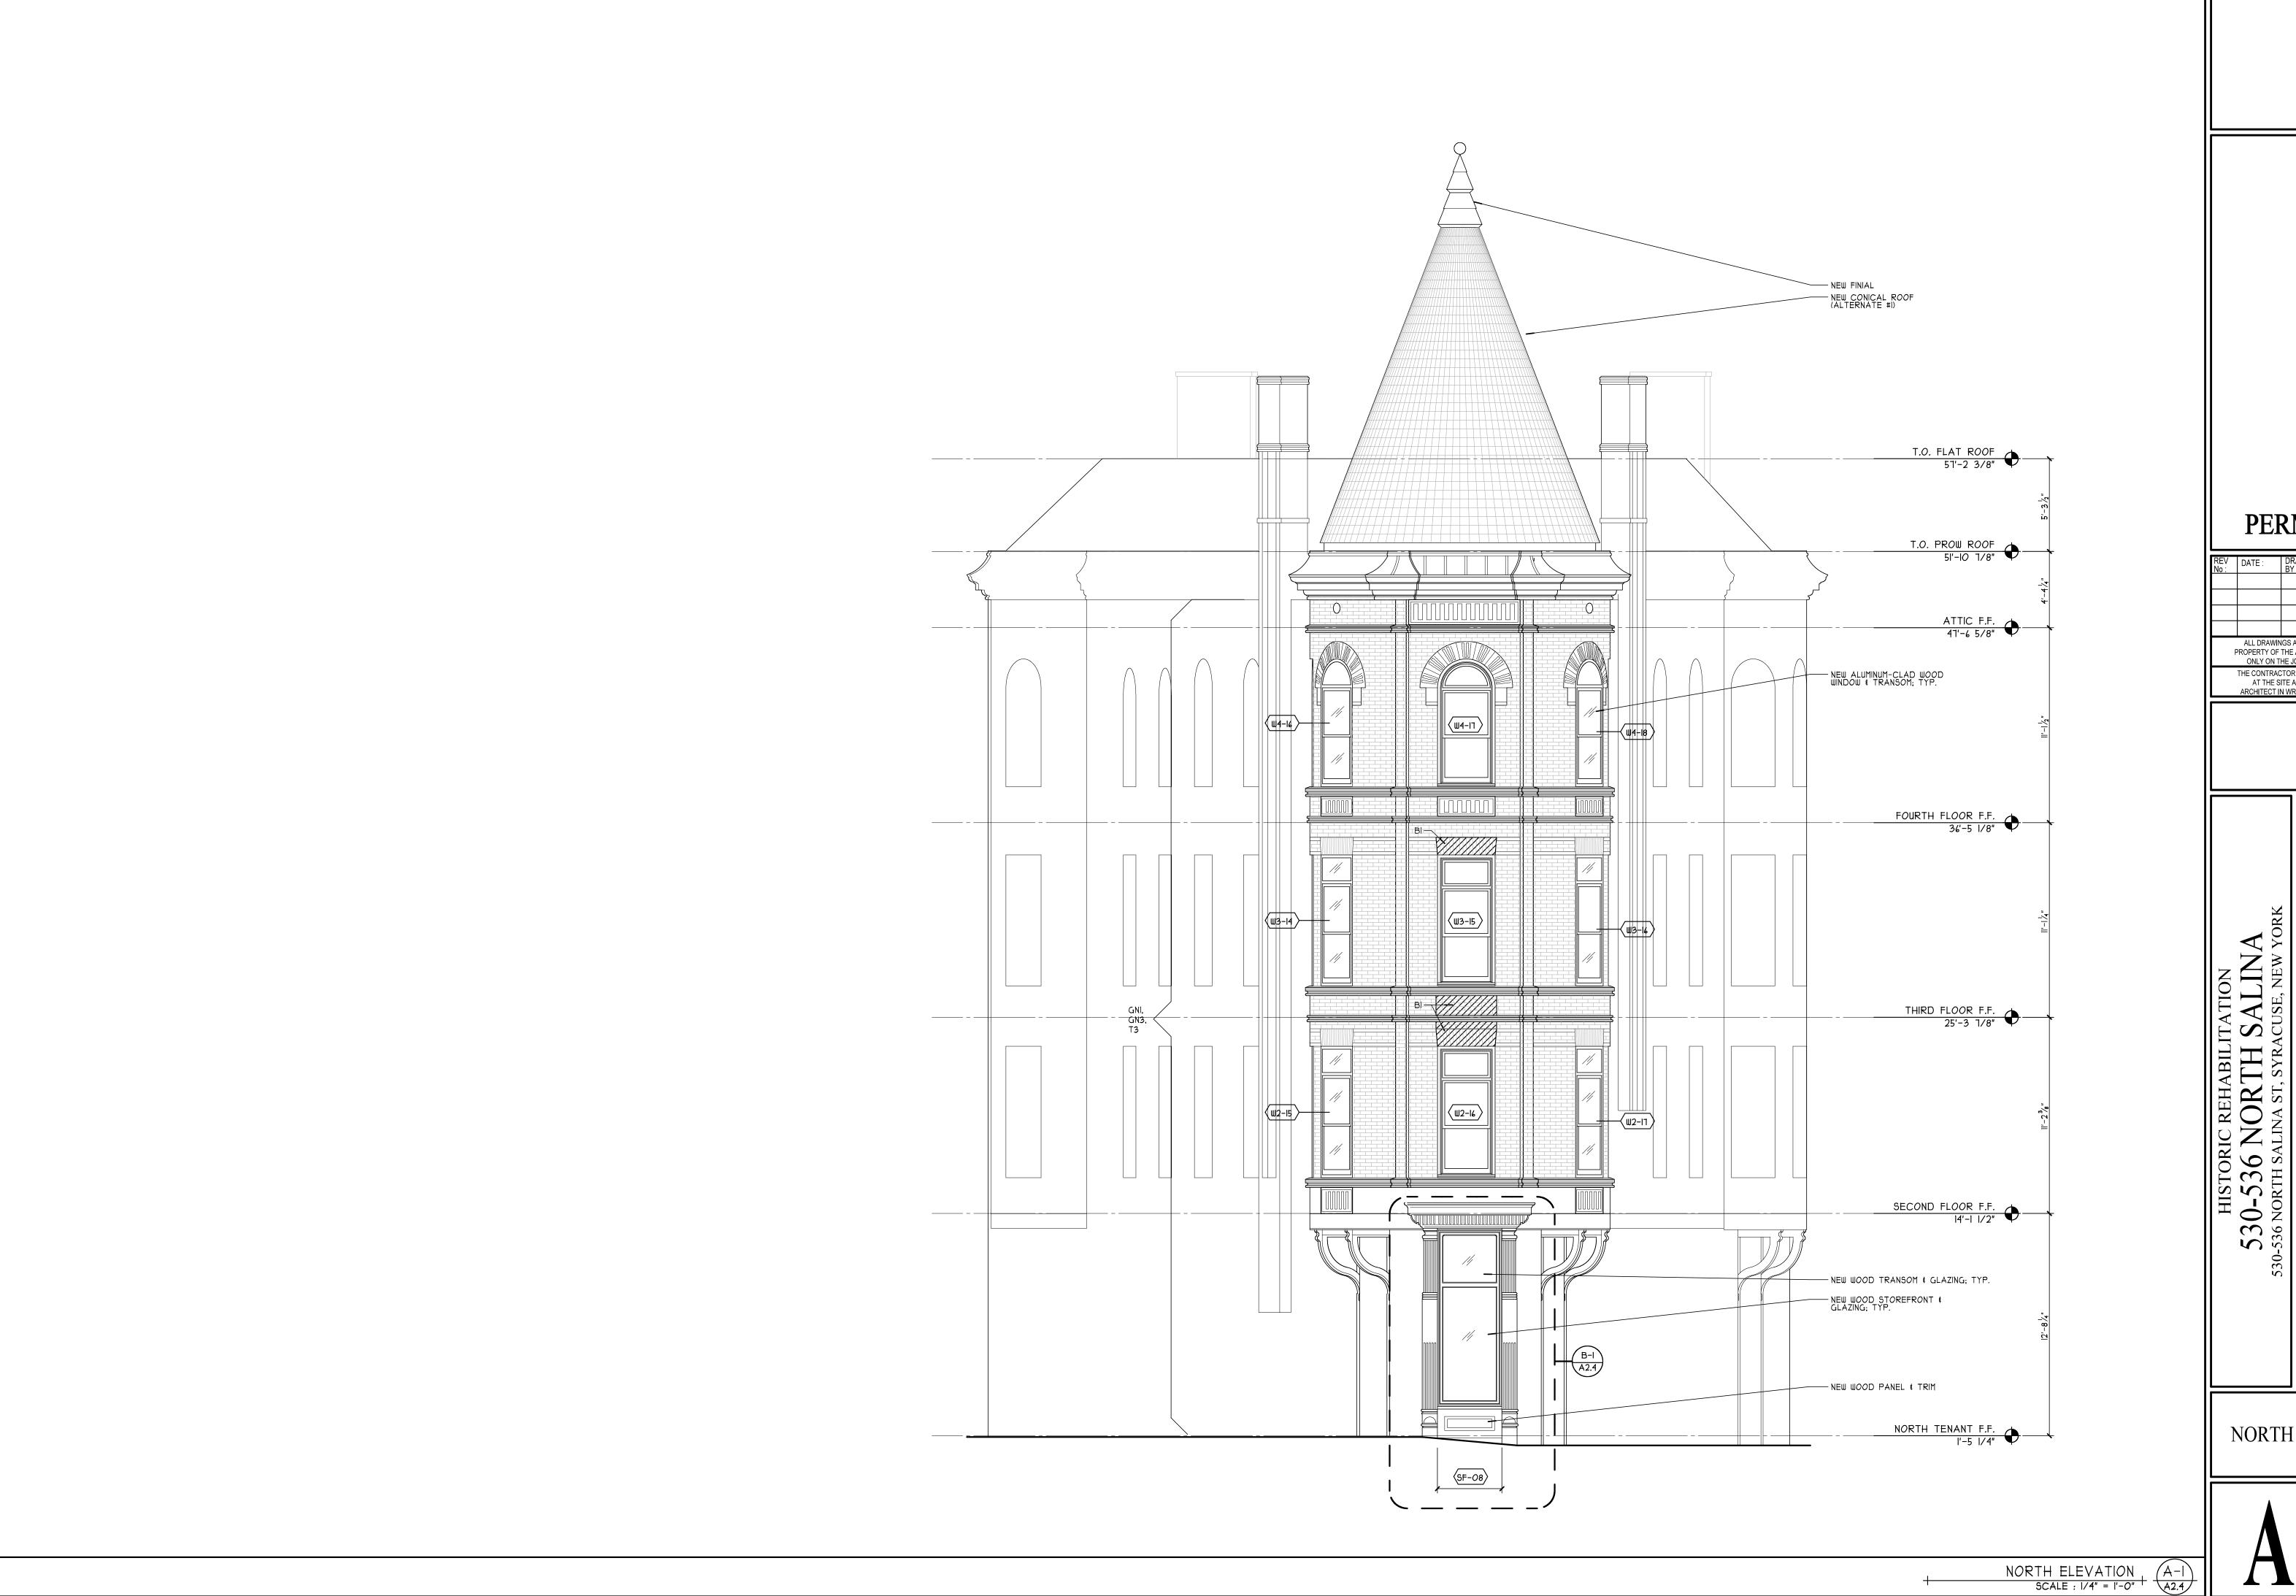

ALL DRAWINGS AND SPECIFICATIONS ARE THE PROPERTY OF THE ARCHITECT, AND SHALL BE USED ONLY ON THE JOB DESIGNATED. COPYRIGHT ©


THE CONTRACTOR SHALL VERIFY ALL DIMENSIONS AT THE SITE AND PROMPTLY NOTIFY THE ARCHITECT IN WRITING OF ANY DISCREPANCIES. JOB NO: 18051

DATE: 08/23/2019

DRAWN BY: CPN SCALE: 1/4" = 1'-0"

NORTH ELEVATION

City of Syracuse - Project Site Review Product Specifications

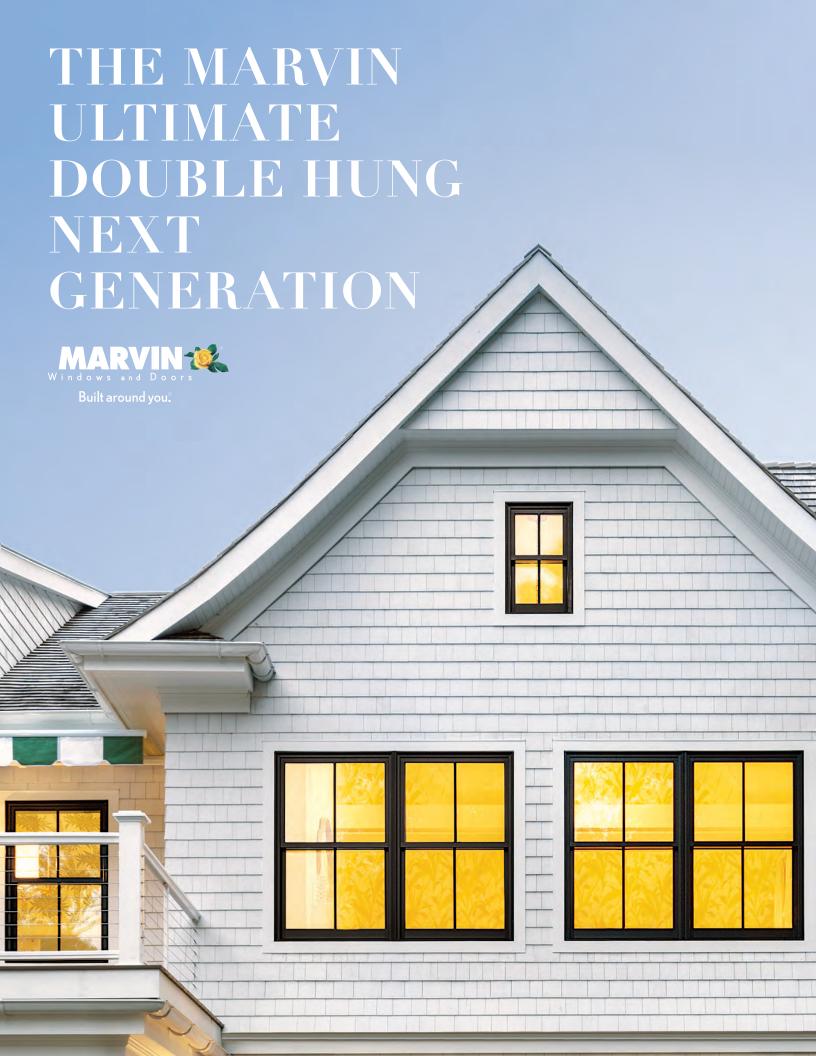

ULTIMATE DOUBLE HUNG NEXT GENERATION



A CONTEMPORARY CLASSIC

The Ultimate Double Hung Next Generation Window is an embodiment of our dedication to the trade of creating windows and doors. Influenced by the rich, historical significance of this window style and inspired by innovative design, each feature is thoughtfully added and each detail is carefully considered.

Window above shown in Designer Black painted interior finish with Matte Black hardware. Right window shown with White painted interior finish and Satin Chrome hardware.

INTERIOR PRODUCT FEATURES

DESIGNED TO INSPIRE

1

RICH WOOD INTERIOR

Offers beauty and warmth with six standard wood species and ten interior finish options.

2

NARROW CHECKRAIL

Provides a sleek aesthetic to maximize daylight opening while maintaining historical accuracy.

3

DESIGN VERSATILITY

With an array of simulated divided lite patterns, interior and exterior color options, ten hardware finishes, and hundreds of roundtop sizes.

4

EXCLUSIVE AUTOLOCK

Activates when the sashes are closed, locking the window.

5

FIRST-RATE ENERGY EFFICIENCY

Meet ENERGY STAR® standards in energy efficiency with multiple glass options for various regions, climates and weather needs.

6

SASH BALANCE SYSTEMS

Enable smooth operation even at the largest sizes.



EXTERIOR PRODUCT FEATURES

ENGINEERED FOR PERFORMANCE

7

DURABLE EXTERIOR CLADDING

Made with the industry's highest level of certification, AAMA 2605, extruded aluminum and backed by a 20-year warranty against chalking and fading.

8

ALUMINUM INTER-LOCK

Eliminates drafts and improves the window's overall structural integrity.

9

EXPANSIVE SIZES

Up to 5 feet wide by 10 feet high.

10

TRADITIONAL SILL BEVEL

The 14-degree bevel provides optimal water management while maintaining a classic look.

1

SUPERIOR WEATHER PERFORMANCE

The window's performance ratings are top in class, including CW-PG30 through CW-PG50 and LC-PG50 on most sizes and IZ3 certified coastal options.






A WINDOW INTO EFFICIENCY

This window's frame-in-frame design is built precisely to seamlessly fit into your unique window opening, so there's no need to remove the existing frame or disturb the exterior or interior trim of your house. Ultimate Insert Double Hung Next Generation Windows always fit into your existing space and appear completely integrated into your home.



ULTIMATE SINGLE HUNG NEXT GENERATION

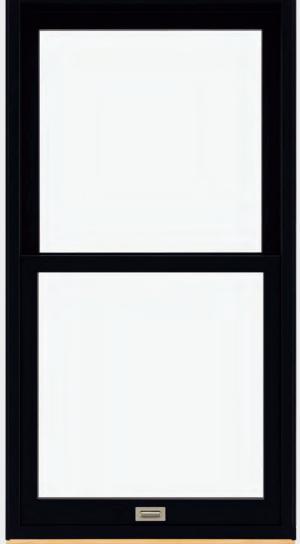

A MODERN INNOVATION

The Marvin® Lift Lock is the next innovation in function, design, and aesthetics for the Marvin Ultimate Single Hung Next Generation Window. Now operating your window is easier than ever; the lift lock unlocks and acts as a handle for raising and lowering the bottom sash. To lock, simply close the bottom sash. Lift Lock Hardware is available with contemporary and traditional styles to complement a range of designs.

Left window shown in Pine with White painted interior finish and Traditional Lift Lock Hardware in Matte Black. Left Window above shown in White Oak with Traditional Lift Lock Hardware in Satin Nickel. Right window above shown in Pine with Designer Black painted interior finish and Contemporary Lift Lock Hardware in Satin Nickel.





SUPERIOR SCREENS

Because no two projects are the same, Marvin® offers a variety of innovative screen and storm window options designed to blend into your window, meet the performance needs of your project, and match the beauty of your home.

RETRACTABLE SCREEN
FULL OR HALF SCREEN
TWO-LITE STORM SASH OR SCREEN
STORM & SCREEN COMBINATIONS



SHADED IN SERENITY

From the amount of light to give your home to the amount of privacy to give yourself, what you need throughout the day changes. Marvin's interior shades are seamlessly integrated into the window with no edge gaps for light to bleed through and feature top- down/bottom-up operation, letting you choose your exact amount of daylight or privacy. With finish options to match your windows or doors, a precision fit with no visible cords or pulleys, these shades blend into the background when unused. Offering fifteen light-filtering shade colors and five colors that block out light, Marvin* shades are designed to accommodate every need. These shades are made with a durable material that holds its pleat through normal use and we offer a 10-year warranty on all fabrics.




Marvin' Windows and Doors, Warroad, MN 56763. ©2018 Marvin Windows and Doors. All rights reserved. ®Registered trademark of Marvin Windows and Doors. Information regarding status of patent applications, and product features and specifications is subject to change without notice. Colors shown in printed materials are simulations and may not precisely duplicate product or finish colors. Contact your local Marvin dealer to view actual product and finish samples.

Part #19980680. June 2018.

MARVINWINDOWS.COM





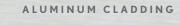

BEAUTY THAT DOESN'T FADE

Our cladding offers color flexibility to meet design goals with durability to protect against the elements. Backed by a 20-year warranty, Marvin's impact resistant extruded aluminum cladding is 3x thicker and much stronger than the industry-standard roll-form aluminum. **

Standing out for its extraordinary durability in nineteen spectacular colors, all finished in commercial-grade paint for superior resistance to chalking and fading, our aluminum cladding is designed to last.



ENHANC€





COCONUT












INTERIOR FINISH OPTIONS

As part of our commitment to only creating the highest-quality windows and doors, every single piece of wood in each of our made-to-order products is conditioned, sanded, and baked during our integrated conditioning and staining process to provide an elegant and lasting finish. With nine stain and paint options to choose from, our customers can receive stunning, ready-to-install windows and doors without the mess, fumes, or inconvenience.

^{*} Pearlescent Aluminum Cladding

^{**} Some colors may not qualify for the 20-year warranty. For details contact your local dealer. For a copy of the warranty, see MarvinWindows.com

City of Syracuse - Project Site Review Photographs - Existing Structure

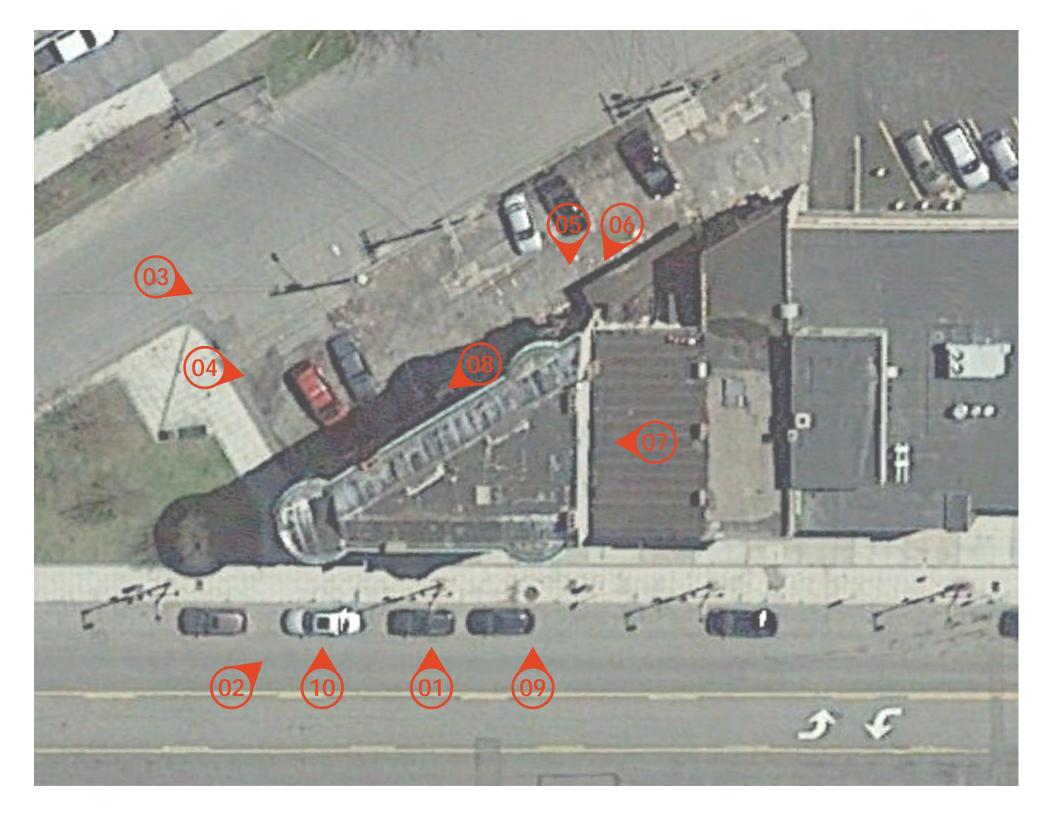





















City of Syracuse - Project Site Review Photographs - Streetscape

