

City of Syracuse
Office of Zoning Administration

**ANTENNA / TOWER / SATELLITE DISH
APPLICATION**

City Hall Commons - Room 500 * 201 E. Washington Street * Syracuse, NY 13202-1426
315-448-8640 * [zoning@syr.gov.net](mailto:zoning@syr.gov) * www.syr.gov.net/Zoning.aspx

Office Use Filing Date: _____ Case: _____ Zoning District: _____

REQUESTED (Check applicable and briefly describe.)

Type	Proposed or Upgraded	
<input checked="" type="checkbox"/> Antenna:	Proposed	locate three (3) communications antennas on the rooftop located at 122 W Seneca Turnpike
<input type="checkbox"/> Tower:		
<input type="checkbox"/> Satellite Dish:		

TAX ASSESSMENT ADDRESS(ES)	TAX MAP ID(S) (000.-00-00.0)	OWNER(S)	DATE ACQUIRED
1) 122 W Seneca Turnpike, Syracuse, 13205	Tax Map 071.-19-21.0	Valley Vista, LLC	1993
2) _____	_____	_____	_____
3) _____	_____	_____	_____
4) _____	_____	_____	_____

As listed in the Department of Assessment property tax records at <http://syr.gov.net/Assessment.aspx> - 315-448-8280.

COMPANION ZONING APPLICATION(S) (List any related City Zoning applications, if applicable, e.g., Resubdivision, Special Permit, Project Site Review, etc.)

1) N/A _____ 2) _____ 3) _____

PROJECT DESCRIPTION (Provide a brief description of the project, including and purpose or need, and justification.)

Tilson Technology Management, Inc., ("Tilson") on behalf of Dish Wireless, LLC, ("Dish"), is applying to locate three (3) communications antennas on the rooftop located at 122 W Seneca Turnpike, Syracuse, 13205.

ANTENNA

Proposed or Upgrading	Installation (building or tower)	Antenna Support Structure Construction (describe)	Total Number of Antennas	Total Antenna Structure Height (feet)	Building Installations	
					Base Antenna Height Above Grade (feet)	Maximum Antenna Height Above Roof Line (feet)
Proposed	building	panel antenna mounts and antenna frames on roof	3	6	63	8

TOWER

Proposed or Upgrading	Number of Service Providers	Construction Type (monopole, lattice work, guyed support, etc.)	Maximum Tower Height (feet)	Minimum Distance to Property Boundary (feet)	Color	Lighting	Accessory Equipment / Enclosure / Pad / Building (type and square feet)

SATELLITE DISH

Proposed or Upgrading	Total Number on Property	Diameter (feet)	Location (ground / building / roof)	Distance to Street Line (feet)	Base Height Above Grade (feet)

City of Syracuse Office of Zoning Administration

PROPERTY OWNER(S) (required)

As listed in Department of Assessment property tax records (<http://syrgov.net/Assessment.aspx> - 315-448-8280). If not listed as the owner, please provide proof of ownership, e.g., a copy of the deed. Attorney's signing on behalf of the owner must include a letter describing the legal arrangement. If the property owner is a Corporation or Organization, the person signing must provide member verification. **Contract purchasers, tenants, architects, engineers, contractors, etc. CANNOT sign on behalf of the owner.**

Louis	Fournier	Manager	Valley Vista LLC, Limited Liability Company		
<i>First Name</i>	<i>Last Name</i>	<i>Title</i>	<i>Company</i>		
525 Plum Street		Syracuse	NY	13204	Phone: 315-218-1102
<i>Street Address</i>	<i>Apt / Suite / Other</i>	<i>City</i>	<i>St</i>	<i>Zip</i>	<i>Email:</i> lfournier@suttoncos.com
* Signature: See letter of authorization (Exhibit B) Date: 08/12/2021					

<i>First Name</i>	<i>Last Name</i>	<i>Title</i>	<i>Company</i>		
<i>Street Address</i>	<i>Apt / Suite / Other</i>	<i>City</i>	<i>St</i>	<i>Zip</i>	<i>Phone:</i>
* Signature: _____ Date: _____					

<i>First Name</i>	<i>Last Name</i>	<i>Title</i>	<i>Company</i>		
<i>Street Address</i>	<i>Apt / Suite / Other</i>	<i>City</i>	<i>St</i>	<i>Zip</i>	<i>Phone:</i>
* Signature: _____ Date: _____					

<i>First Name</i>	<i>Last Name</i>	<i>Title</i>	<i>Company</i>		
<i>Street Address</i>	<i>Apt / Suite / Other</i>	<i>City</i>	<i>St</i>	<i>Zip</i>	<i>Phone:</i>
* Signature: _____ Date: _____					

*** OWNER SIGNATURE DECLARATION**

I understand that false statements made herein are punishable as a Class A Misdemeanor, pursuant to section 210.45 of the Penal Law of the State of New York. I declare that, subject to the penalties of perjury, any statements made on this application and any attachments are the truth and to the best of my knowledge correct. I also understand that any false statements and/or attachments presented knowingly in connection with this application will be considered null and void.

APPLICANT(S) (if applicable)

			Dish Wireless, LLC		
<i>First Name</i>	<i>Last Name</i>	<i>Title</i>	<i>Company</i>		
5701 South Santa Fe		Littleton	CO	80120	Phone: (610) 858-5493
<i>Street Address</i>	<i>Apt / Suite / Other</i>	<i>City</i>	<i>St</i>	<i>Zip</i>	<i>Email:</i> chelsea.walters@dish.com
Melanie	Dorn	Staff Attorney	Tilson Technology Management, Inc.		
<i>First Name</i>	<i>Last Name</i>	<i>Title</i>	<i>Company</i>		
16 Middle Street	Fourth Floor	Portland	ME	04101	Phone: 5087891871
<i>Street Address</i>	<i>Apt / Suite / Other</i>	<i>City</i>	<i>St</i>	<i>Zip</i>	<i>Email:</i> mdorn@tilsontech.com

REPRESENTATIVE(S)/CONTACT(S) (if applicable)

16 Middle Street	Dorn	Staff Attorney	Tilson Technology Management, Inc.		
<i>First Name</i>	<i>Last Name</i>	<i>Title</i>	<i>Company</i>		
16 Middle Street	Fourth Floor	Portland	ME	04101	Phone: 5087891971
<i>Street Address</i>	<i>Apt / Suite / Other</i>	<i>City</i>	<i>St</i>	<i>Zip</i>	<i>Email:</i> mdorn@tilsontech.com
<i>First Name</i>	<i>Last Name</i>	<i>Title</i>	<i>Company</i>		
<i>Street Address</i>	<i>Apt / Suite / Other</i>	<i>City</i>	<i>St</i>	<i>Zip</i>	<i>Phone:</i>
* Signature: _____ Date: _____					

**Antenna / Tower / Satellite Dish
Application
PROCEDURES**

Antenna / Tower / Satellite Dish applications are reviewed by the City Planning Commission and may require a public hearing. Meetings are scheduled every three weeks on Mondays at 6:00 p.m. in the Common Council Chambers on the third floor of City Hall, unless otherwise noted. The annual meeting scheduled is posted at http://www.syr.gov.net/Planning_Commission.aspx.

An application will not be considered complete and ready to be heard by the City Planning Commission until all required submittals have been received and have been through a preliminary review by Zoning Office staff, including an evaluation of the application under the New York State Environmental Quality Review Act (SEQR).

Applications are also referred (forwarded) to other departments, typically the Departments of Public Works and Engineering, and the City Division of Planning for review and comment and to also assist with coordinating the project with their requirements. Applications involving historic properties are referred to the Syracuse Landmark Preservation Board for review and comment. Applications involving properties within the jurisdiction of the Onondaga County Planning Board are referred for their review.

This review process will ultimately make the process of obtaining any additional permits, like building permits, more efficient. Applicants will be required to address any comments, often through the modification of the application plans that must be resubmitted to the Syracuse Zoning Office. This review process is often iterative in nature and may require additional review time if the project is complex.

Once an application is complete and reviewed, the application will be placed on the next available City Planning Commission meeting agenda. If a public hearing is required, it must first be authorized at a regularly scheduled meeting by the City Planning Commission for the following regularly scheduled meeting. Following a public hearing authorization, and at least ten (10) days prior to the public hearing date, a "Public Notice" will be published in Syracuse Post Standard as well as mailed to: the applicant and applicant's representative (if applicable); surrounding property owners within at least a 200 foot radius from the applicant's property; and to other City departments and neighborhood organizations. The application and its contents will then be available for inspection at the Syracuse Zoning Office. http://www.syr.gov.net/Planning_Commission.aspx.

The applicant or their representative must present the application to the City Planning Commission. A decision will typically be rendered on the same day, but occasionally the application will be held open until the next meeting pending additional information and/or further consideration.

PLEASE NOTE: Application approval does not relieve you or your representative from compliance with any other regulatory or licensing provisions additionally required by other Federal, State, County, or City authorities. You are still required to pursue and obtain all applicable permits, such as building permits from the Central Permit Office in the Division of Code Enforcement.

Antenna / Tower / Satellite Dish

Application

INSTRUCTIONS AND REQUIRED SUBMITTALS

Incomplete applications will not be processed.

Applications together with the required submittals below must be submitted in **HARD COPY, SINGLE SIDED** and **NOT BOUND**, to the City of Syracuse Office of Zoning Administration, City Hall Commons – Room 500, 201 East Washington St., Syracuse, NY 13202. E-mailed submissions will not be processed.

Please submit **ONE (1) COPY** of the following:

- APPLICATION** – filled out completely, dated, and **signed by property owner(s) as instructed.**
- STATE ENVIRONMENTAL QUALITY REVIEW ACT (SEQR) ASSESSMENT FORM** (for most applications a Short Form (SEAF) - Part One) – filled out to the best of your ability, dated, and signed.
- PHOTOGRAPHS and SIMULATIONS (COLOR)** illustrating before and after photos of the proposed exact location of proposed antenna, tower, or satellite dish.
- APPLICATION FEE** – \$0.

Please submit **THREE FULL-SIZE AND TO-SCALE SETS** for review purposes, and **ONE (1) REDUCED SET** (11x17, or smaller) for copying, of the items listed below. All plans must include a title block with author, date, scale, and Department of Assessment property tax address, and must be an accurate graphic representation of all pertinent information that can be correctly interpreted by any person without additional explanation. Plans do not need to be stamped by a licensed professional unless noted below.

- AS BUILT PROPERTY SURVEY(S)** of all involved properties illustrating **boundaries, easements, and current conditions** including structures, fencing, parking surface, retaining walls (**signed and stamped by a licensed surveyor**).
- SITE PLANS, DRAWINGS, CALCULATIONS, and DOCUMENTATION** (**signed and sealed by a licensed engineer**, as necessary) including:
 1. existing conditions to remain
 2. proposed site changes
 3. existing and proposed structure locations
 4. antenna placement, design, dimensions, and support structure details
 5. tower design, height, materials, colors, lighting, and requirements
 6. distance to street and property lines / setbacks
 7. accessory equipment/components, pads, enclosures, and structures with dimensions
 8. fencing
 9. landscaping
 10. topography and topographic analyses
 11. radio area frequency coverage
 12. additional information as maybe determined by the City Planning Commission

Short Environmental Assessment Form

Part 1 - Project Information

Instructions for Completing


Part 1 – Project Information. The applicant or project sponsor is responsible for the completion of Part 1. Responses become part of the application for approval or funding, are subject to public review, and may be subject to further verification. Complete Part 1 based on information currently available. If additional research or investigation would be needed to fully respond to any item, please answer as thoroughly as possible based on current information.

Complete all items in Part 1. You may also provide any additional information which you believe will be needed by or useful to the lead agency; attach additional pages as necessary to supplement any item.

Part 1 – Project and Sponsor Information			
Tilson Technology Management, Inc., on behalf of Dish Wireless, LLC,			
Name of Action or Project: SYSYR00355B			
Project Location (describe, and attach a location map): 122 W. SENECA TURNPIKE			
Brief Description of Proposed Action: Tilson Technology Management, Inc., ("Tilson") on behalf of Dish Wireless, LLC, ("Dish"), is applying to locate three (3) communications antennas on the rooftop located at 122 W Seneca Turnpike, Syracuse, 13205. This property is owned by Valley Vista LLC, Limited Liability Company with a mailing address of 525 Plum Street, Syracuse, New York, 13204 ("Landlord").			
Name of Applicant or Sponsor: Melanie Dorn		Telephone: 5087891871 E-Mail: mdorn@tilsontech.com	
Address: 16 Middle Street, Fourth Floor			
City/PO: Portland		State: ME	Zip Code: 04101
1. Does the proposed action only involve the legislative adoption of a plan, local law, ordinance, administrative rule, or regulation? If Yes, attach a narrative description of the intent of the proposed action and the environmental resources that may be affected in the municipality and proceed to Part 2. If no, continue to question 2.			NO <input type="checkbox"/>
			YES <input checked="" type="checkbox"/>
2. Does the proposed action require a permit, approval or funding from any other government Agency? If Yes, list agency(s) name and permit or approval:			NO <input type="checkbox"/>
			YES <input checked="" type="checkbox"/>
3. a. Total acreage of the site of the proposed action? _____ >1 acres b. Total acreage to be physically disturbed? _____ >1 acres c. Total acreage (project site and any contiguous properties) owned or controlled by the applicant or project sponsor? _____ 0 acres			
4. Check all land uses that occur on, are adjoining or near the proposed action:			
5. <input checked="" type="checkbox"/> Urban <input type="checkbox"/> Rural (non-agriculture) <input type="checkbox"/> Industrial <input type="checkbox"/> Commercial <input type="checkbox"/> Residential (suburban) <input type="checkbox"/> Forest <input type="checkbox"/> Agriculture <input type="checkbox"/> Aquatic <input type="checkbox"/> Other(Specify): <input type="checkbox"/> Parkland			

		NO	YES	N/A
5. Is the proposed action,	a. A permitted use under the zoning regulations?	<input type="checkbox"/>	<input checked="" type="checkbox"/>	<input type="checkbox"/>
	b. Consistent with the adopted comprehensive plan?	<input type="checkbox"/>	<input checked="" type="checkbox"/>	<input type="checkbox"/>
6. Is the proposed action consistent with the predominant character of the existing built or natural landscape?		<input type="checkbox"/>	<input checked="" type="checkbox"/>	NO YES
7. Is the site of the proposed action located in, or does it adjoin, a state listed Critical Environmental Area? If Yes, identify: _____		<input checked="" type="checkbox"/>	<input type="checkbox"/>	NO YES
8. a. Will the proposed action result in a substantial increase in traffic above present levels? b. Are public transportation services available at or near the site of the proposed action? c. Are any pedestrian accommodations or bicycle routes available on or near the site of the proposed action?		<input checked="" type="checkbox"/>	<input type="checkbox"/>	NO YES
		<input type="checkbox"/>	<input checked="" type="checkbox"/>	
		<input type="checkbox"/>	<input checked="" type="checkbox"/>	
9. Does the proposed action meet or exceed the state energy code requirements? If the proposed action will exceed requirements, describe design features and technologies: _____ _____		<input type="checkbox"/>	<input checked="" type="checkbox"/>	NO YES
10. Will the proposed action connect to an existing public/private water supply? If No, describe method for providing potable water: _____ _____		<input checked="" type="checkbox"/>	<input type="checkbox"/>	NO YES
11. Will the proposed action connect to existing wastewater utilities? If No, describe method for providing wastewater treatment: _____ _____		<input checked="" type="checkbox"/>	<input type="checkbox"/>	NO YES
12. a. Does the project site contain, or is it substantially contiguous to, a building, archaeological site, or district which is listed on the National or State Register of Historic Places, or that has been determined by the Commissioner of the NYS Office of Parks, Recreation and Historic Preservation to be eligible for listing on the State Register of Historic Places? b. Is the project site, or any portion of it, located in or adjacent to an area designated as sensitive for archaeological sites on the NY State Historic Preservation Office (SHPO) archaeological site inventory?		<input checked="" type="checkbox"/>	<input type="checkbox"/>	NO YES
		<input type="checkbox"/>	<input checked="" type="checkbox"/>	
13. a. Does any portion of the site of the proposed action, or lands adjoining the proposed action, contain wetlands or other waterbodies regulated by a federal, state or local agency? b. Would the proposed action physically alter, or encroach into, any existing wetland or waterbody? If Yes, identify the wetland or waterbody and extent of alterations in square feet or acres: _____ _____ _____		<input type="checkbox"/>	<input checked="" type="checkbox"/>	NO YES
		<input type="checkbox"/>	<input type="checkbox"/>	

14. Identify the typical habitat types that occur on, or are likely to be found on the project site. Check all that apply: <input type="checkbox"/> Shoreline <input type="checkbox"/> Forest <input type="checkbox"/> Agricultural/grasslands <input type="checkbox"/> Early mid-successional <input type="checkbox"/> Wetland <input checked="" type="checkbox"/> Urban <input type="checkbox"/> Suburban		
15. Does the site of the proposed action contain any species of animal, or associated habitats, listed by the State or Federal government as threatened or endangered? Indiana Bat, Northern Long-...	NO	YES
	<input type="checkbox"/>	<input checked="" type="checkbox"/>
16. Is the project site located in the 100-year flood plan?	NO	YES
	<input checked="" type="checkbox"/>	<input type="checkbox"/>
17. Will the proposed action create storm water discharge, either from point or non-point sources? If Yes, a. Will storm water discharges flow to adjacent properties? b. Will storm water discharges be directed to established conveyance systems (runoff and storm drains)? If Yes, briefly describe: _____	NO	YES
	<input checked="" type="checkbox"/>	<input type="checkbox"/>
	<input checked="" type="checkbox"/>	<input type="checkbox"/>
	<input checked="" type="checkbox"/>	<input type="checkbox"/>
18. Does the proposed action include construction or other activities that would result in the impoundment of water or other liquids (e.g., retention pond, waste lagoon, dam)? If Yes, explain the purpose and size of the impoundment: _____	NO	YES
	<input checked="" type="checkbox"/>	<input type="checkbox"/>
19. Has the site of the proposed action or an adjoining property been the location of an active or closed solid waste management facility? If Yes, describe: _____	NO	YES
	<input checked="" type="checkbox"/>	<input type="checkbox"/>
20. Has the site of the proposed action or an adjoining property been the subject of remediation (ongoing or completed) for hazardous waste? If Yes, describe: _____	NO	YES
	<input checked="" type="checkbox"/>	<input type="checkbox"/>
I CERTIFY THAT THE INFORMATION PROVIDED ABOVE IS TRUE AND ACCURATE TO THE BEST OF MY KNOWLEDGE Applicant/sponsor/name: <u>Melanie Dorn</u> Date: <u>8/12/2021</u> Signature: <u>Mel Dorn</u> Title: <u>Staff Attorney</u>		

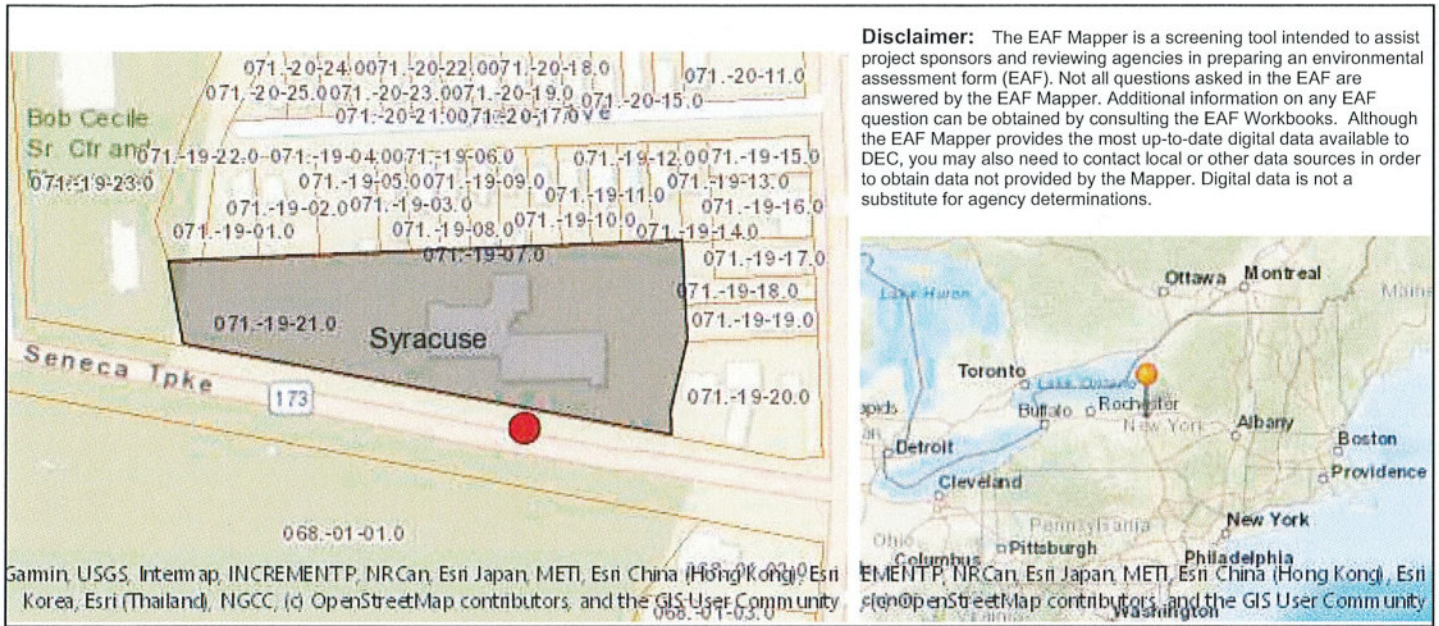

Disclaimer: The EAF Mapper is a screening tool intended to assist project sponsors and reviewing agencies in preparing an environmental assessment form (EAF). Not all questions asked in the EAF are answered by the EAF Mapper. Additional information on any EAF question can be obtained by consulting the EAF Workbooks. Although the EAF Mapper provides the most up-to-date digital data available to DEC, you may also need to contact local or other data sources in order to obtain data not provided by the Mapper. Digital data is not a substitute for agency determinations.

Part 1 / Question 7 [Critical Environmental Area]	No
Part 1 / Question 12a [National or State Register of Historic Places or State Eligible Sites]	No
Part 1 / Question 12b [Archeological Sites]	Yes
Part 1 / Question 13a [Wetlands or Other Regulated Waterbodies]	Yes - Digital mapping information on local and federal wetlands and waterbodies is known to be incomplete. Refer to EAF Workbook.
Part 1 / Question 15 [Threatened or Endangered Animal]	Yes
Part 1 / Question 15 [Threatened or Endangered Animal - Name]	Indiana Bat, Northern Long-eared Bat
Part 1 / Question 16 [100 Year Flood Plain]	No
Part 1 / Question 20 [Remediation Site]	No

August 9, 2021

Office of Zoning Administration
ATTN: Jeff Harrop
201 East Washington Street, Room 500
City of Syracuse, New York 13202

RE: Application to Co-locate Communications Antenna Array on Rooftop Located at 122 W Seneca Turnpike, Syracuse, 13205

To Whom it May Concern,

Tilson Technology Management, Inc., ("Tilson") on behalf of Dish Wireless, LLC, ("Dish"), is applying to locate three (3) communications antennas on the rooftop located at 122 W Seneca Turnpike, Syracuse, 13205. This property is owned by Valley Vista LLC, Limited Liability Company with a mailing address of 525 Plum Street, Syracuse, New York, 13204 ("Landlord"). Dish has authorization from the Landlord to apply for such permits, as demonstrated in the exhibits in this application. Tilson respectfully requests that the Office of Zoning Administration review this application and schedule review for the next available Planning Commission meeting.

In accordance with Syracuse Zoning Ordinance ("Ordinance"), Part C, Section I, Article 7, rooftop communications antennas in residential districts are permissible through Site Plan Approval, so long as the site meets design standards set out in the Ordinance. This property, Tax Map 071.-19-21.0, is within the Residential District, Class B, ("RB").

Tilson is providing the following Exhibits along with this application to apply for Site Plan Review according to Ordinance, Part C, Section I, Article 7(F):

- Completed Antenna Application Form (Attachment 1)
- Zoning Compliance Letter (Exhibit A)
- Letter of Authorization (Exhibit B)
- State Environmental Quality Review (SEQR) Assessment Form (Exhibit C)
- Photographs and Photo Simulations (Exhibit D)
- Property Survey (Exhibit E)

- Site Plan Drawing (Exhibit F)
- Radio Frequency Coverage Map (Exhibit G)

Please let us know if there is anything further needed to complete this application.

Thank you for your time.

Respectfully,

A handwritten signature in dark ink, appearing to read "Melanie Dorn". The signature is fluid and cursive, with a long horizontal stroke at the end.

Melanie Dorn
Staff Attorney
16 Middle Street, Fourth Floor
Portland ME 04101
mdorn@tilsontech.com
508.789.1871

August 9, 2021

Office of Zoning Administration
ATTN: Jeff Harrop
201 East Washington Street, Room 500
City of Syracuse, New York 13202

RE: (Exhibit A) Zoning Compliance, Communications Antenna Array on Rooftop Located at 122 W Seneca Turnpike, Syracuse, 13205

To Whom it May Concern,

Tilson Technology Management, Inc., (“Tilson”) on behalf of Dish Wireless, LLC, (“Dish”), is applying to locate three (3) communications antennas on the rooftop located at 122 W Seneca Turnpike, Syracuse, 13205. This property is owned by Valley Vista LLC, Limited Liability Company with a mailing address of 525 Plum Street, Syracuse, New York, 13204 (“Landlord”). This property, Tax Map 071.-19-21.0, is within the Residential District, Class B, (“RB”).

To demonstrate compliance with the Syracuse Zoning Ordinance, Tilson is submitting this letter marked Exhibit A. In accordance with Syracuse Zoning Ordinance (“Ordinance”), Part C, Section I, Article 7, rooftop communications antennas in residential districts are permissible through Site Plan Approval, so long as the site meets design standards set out in the Ordinance.

- **Ordinance Part C, Section I, Article 7 (“Article 7”) Section A**, states:

“These regulations are established in order to minimize the impact of telecommunication antennas and their supporting structures and frameworks, including towers and dishes, on the visual quality and general welfare of the City of Syracuse.”

Article 7(A).

Tilson and Dish (together “Applicants”) have worked diligently to design this site in order to create the least visually intrusive communications antennas, as is demonstrated in Exhibit D. Additionally, by locating antennas on a rooftop and utilizing its existing structure height, the number of towers within the City is reduced.

- **Article 7(B)** outlines the definitions under this Article. The scope of this project is adding additional antennas to the rooftop at 122 W Seneca Turnpike. This project meets the definition of antenna, which

is defined as “[a]ny exterior transmitting or receiving device mounted on a tower, building, or other support structure fixed to the ground and used in communications that radiate or capture electromagnetic waves, digital signals, analog signals, radio frequencies (excluding radar signals), wireless telecommunications signals or other communications signals.” Article 7(B). The facilities being proposed at this site will provide wireless telecommunications signals in order to offer better coverage for the City.

- **Article 7(C)** outlines the siting parameters applicable to communications antennas.

Article 7(C)(1)(a) states that in all zoning districts, antennas must be at least 30’ above grade and not extend more than 20’ above the building roof lines. As demonstrated in Exhibit F of this application, the proposed antennas would be mounted over 30’ above grade, at a height of 63’ above grade. Additionally, the antenna will extend approximately 9’ above the existing roof line, which is well within the limit of 20’.

Article 7(C)(1)(b)(1) states that in residential districts, antennas shall be in accordance with height limits outlined in Article 7(C)(1)(a), which was noted above will be met by this proposal.

Article 7(C)(1)(b)(2) states that antennas must be installed in accordance with Article 7(D), which is outlined below in this letter.

Article 7(C)(1)(b)(3) Tilson and Dish, with this letter, are applying for Site Plan Approval according to this section and Article 7(F).

Article 7(C)(1)(b)(4) this project is proposed to be installed on a building that does not have wood framing. In addition, this building has more than four dwelling units.

- **Article 7(D)** outlines “General Standards for Towers and Antennas (not including Satellite Dish Antennas”).

Article 7(D)(1) is not applicable as this proposal is not for a new tower.

Article 7(D)(2) this proposed communications antenna array will comply with all setbacks required of the underlying zone, which are outlined in Ordinance Part B, Section I, Article 8(4), as the building is setback over 10’ from W Seneca Turnpike in the front yard, and over the 15% of total front width of the lot in the side yard.

Article 7(D)(3)— (8) are not applicable as this proposal is not for a new tower.

Article 7(D)(9) No lighting is proposed for this antenna array.

Article 7(D)(10) The equipment ancillary to this proposed antenna array will be located as to maintain the least visually intrusive footprint to passersby. This can be seen on the photo simulation provided as a part of this application packet in Exhibit D.

Article 7(D)(11) This site will comply with all Federal and Local standards.

Article 7(D)(12) No signs are proposed with this site except for small contact information provided on the site.

- **Article 7(F) Site Plan Review**

Article 7(F)(1) The Applicants are applying for Site Plan Approval as required by this Article. This letter is provided to show that the standards have been met, and Exhibit G is provided to demonstrate a need for this proposed communications antenna array.

Article 7(F)(2) Waivers This section is not applicable to this application.

Article 7(F)(3) The Applicants recognize that the Planning Commission may impose reasonable conditions on this proposal.

Article 7(F)(4) The Applicants recognize that because this site is within a residential district, the review by the Planning Commission shall include a Public Hearing.

Article 7(F)(5) The applicants have provided the following in compliance with this section

A property survey (Exhibit E)

Scaled site plan (Exhibit F)

Scaled elevation view (Exhibit F)

Drawings demonstrating the location and dimensions of the proposal (Exhibit F)

Radio frequency coverage (Exhibit G)

- **Article 7(H), (I).** The Applicants recognize that antennas must be removed within 90' days of receipt of notice of the Building Officials should the proposal be abandoned. The Applicants also acknowledge that this Article shall be severable.

As demonstrated above and in the Exhibits for this application, Tilson and Dish respectfully request that the City approve this application as it complies with the City Zoning Ordinance.

Thank you for your time.

Respectfully,

A handwritten signature in cursive script, appearing to read 'Melanie Dorn', written in dark ink.

Melanie Dorn
Staff Attorney
16 Middle Street, Fourth Floor
Portland ME 04101
mdorn@tilsontech.com
508.789.1871



July 30, 2021

**RE: Owner Authorization to Submit Applications for Required Permits and
Regulatory Approvals
Tower Owner: Valley Vista LLC
Tower Tenant/Lessee: Dish Wireless, LLC**


To Whom It May Concern:

This letter authorizes Dish Wireless, LLC, and their agent, Tilson Technology Management, Inc., to apply for all necessary permits in order to add an additional communications antenna array and related equipment to the rooftop of the building that the undersigned owns, located at 122 W Seneca Turnpike in Syracuse.

Very Truly Yours,

A handwritten signature in blue ink, appearing to read "Louis G. Fournier III".

Louis G. Fournier III, CPM
Manager

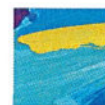

TILSON


On a Mission

TEMSCO

[SYSYR00355B] – Alpha Angle

Before Installation



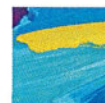

TILSON

On a Mission

TEMSCO

[SYSYR00355B] – Alpha Angle

After Installation





TILSON

On a Mission

TEMSCO

[SYSYR00355B] – Beta Angle

Before Installation





TILSON

On a Mission

TEMSCO

[SYSYR00355B] – Beta Angle

After Installation





TILSON


On a Mission

TEMSCO

[SYSYR00355B] – Gamma Angle

Before Installation



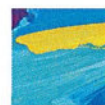


TILSON
On a Mission

TEMSCO

[SYSYR00355B] – Gamma Angle

After Installation



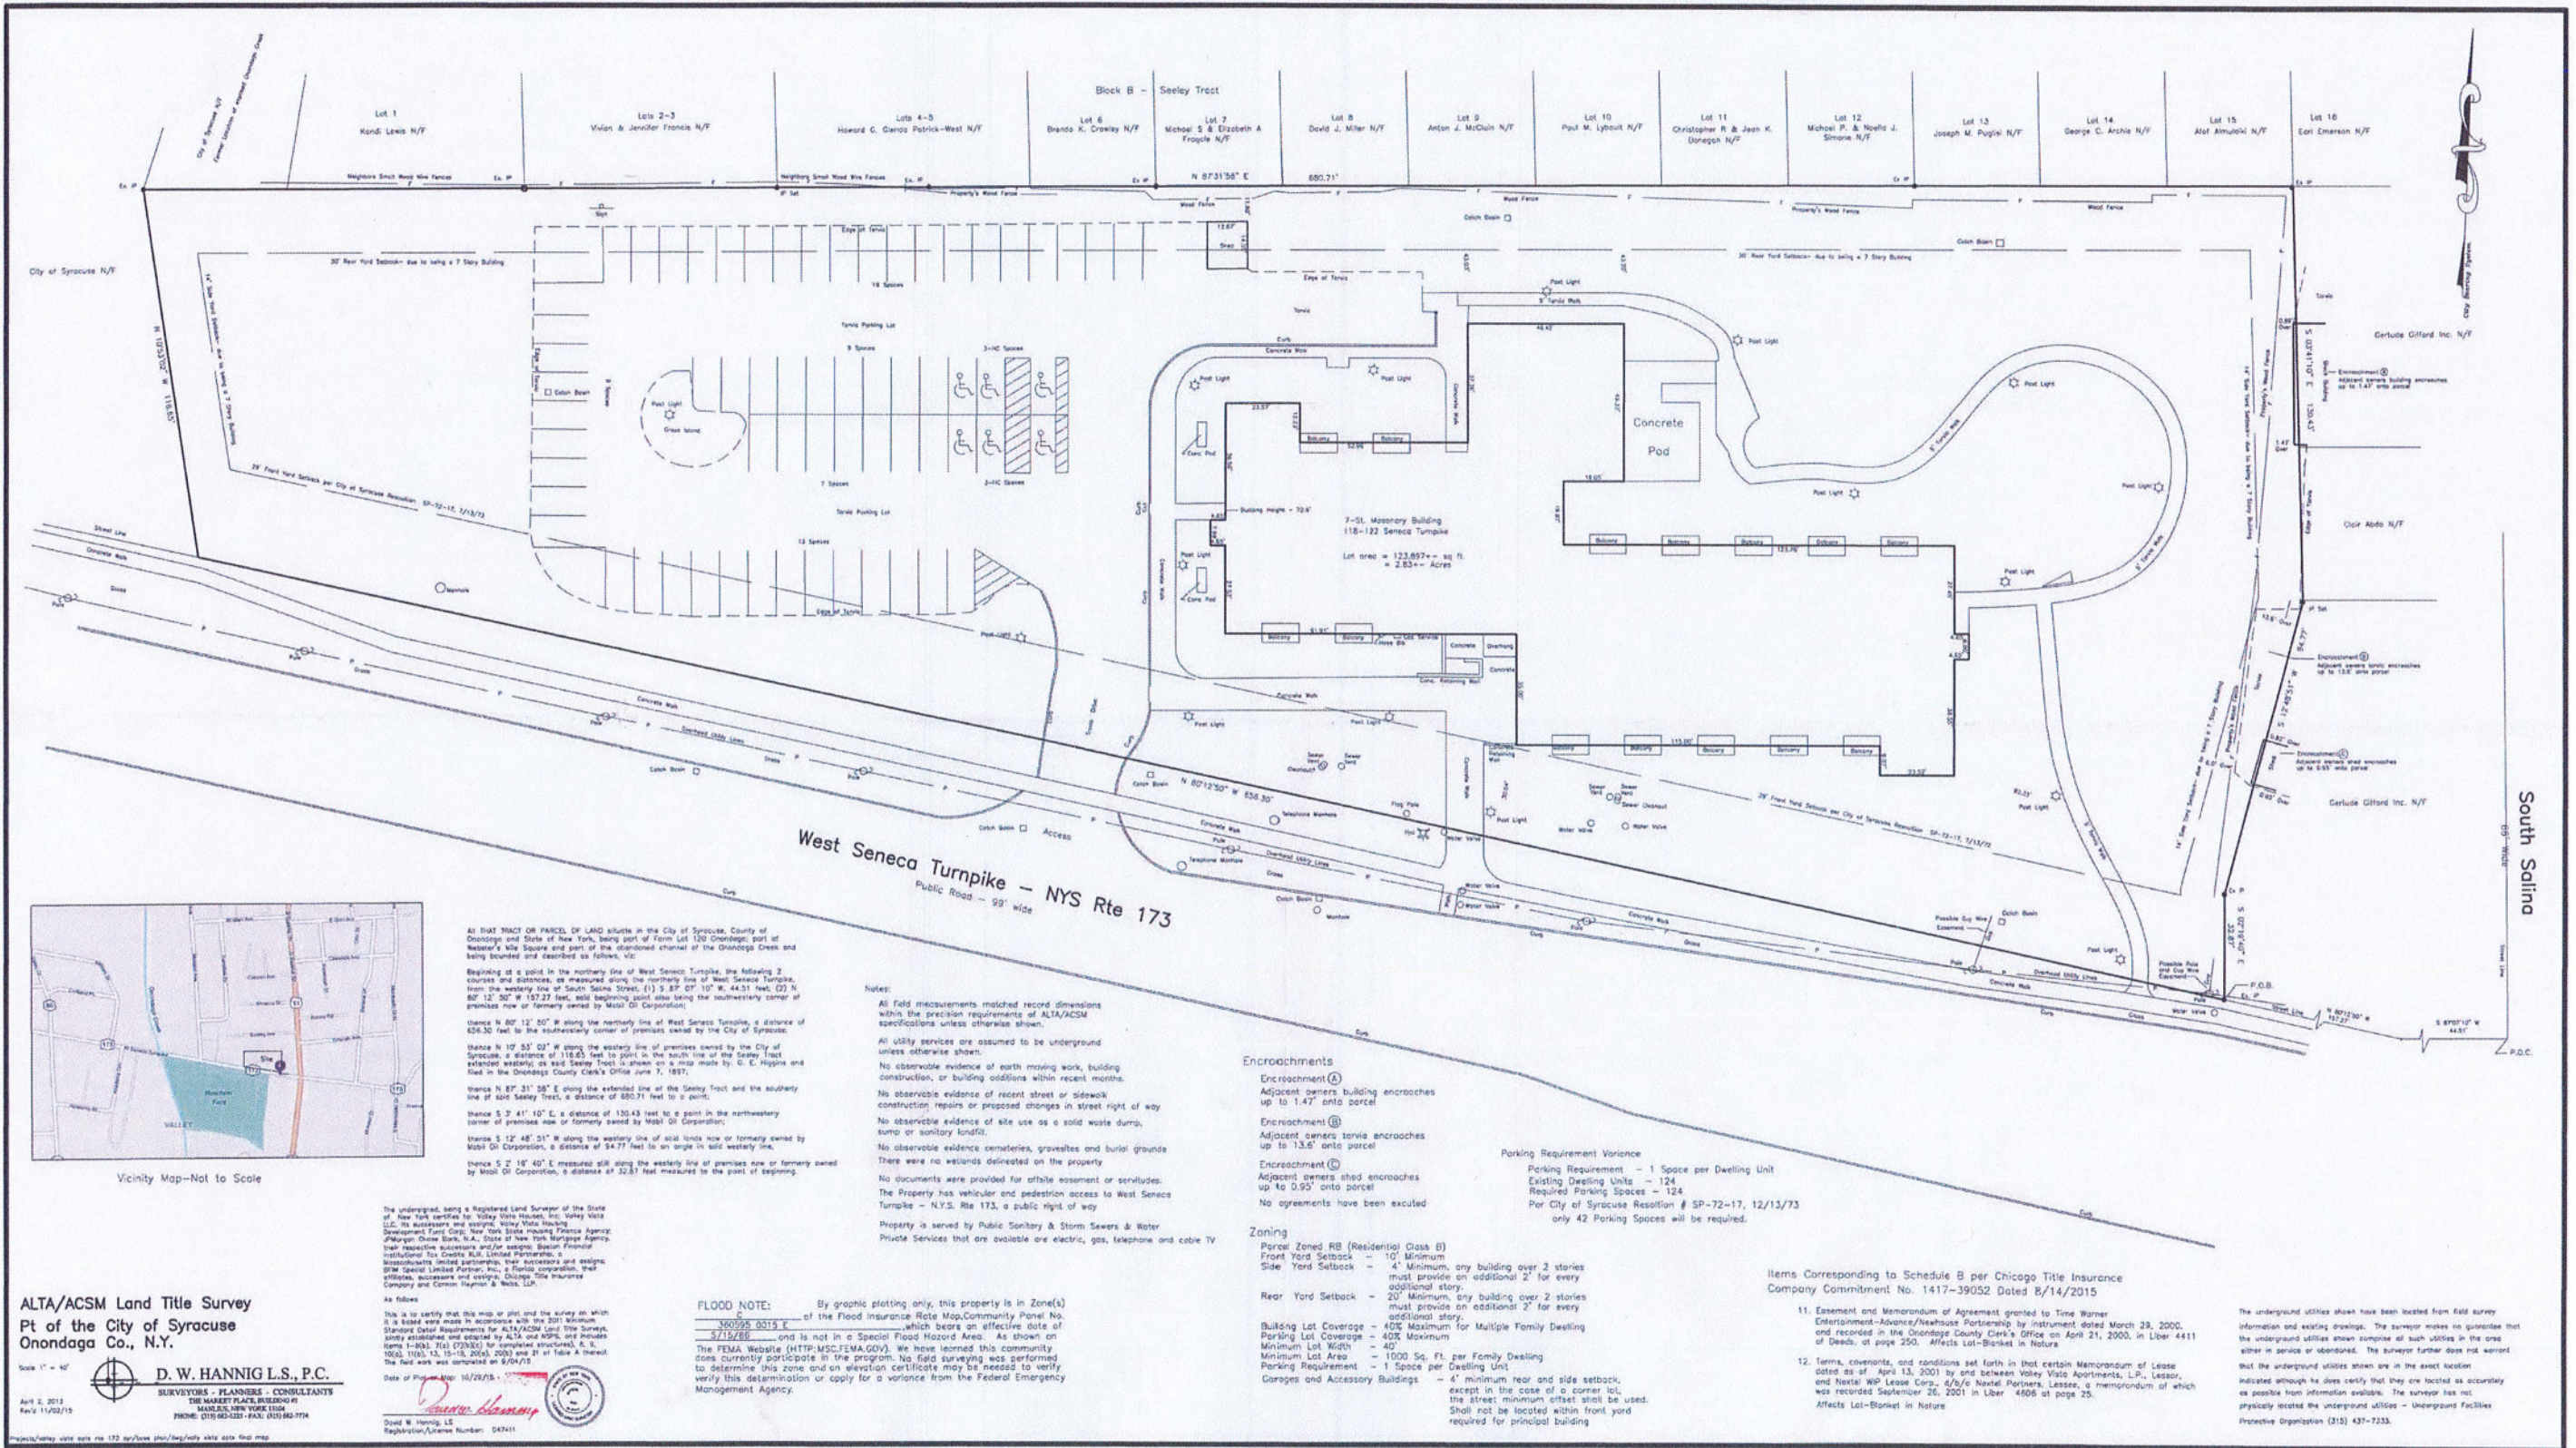

All that TRACT OR PARCEL OF LAND situated in the City of Syracuse, County of Onondaga and State of New York, being part of Farm Lot 100 Onondaga, part of Webster's Mill Square and part of the abandoned channel of the Onondaga Creek and being bounded and described as follows: V.S.

Beginning at a point in the northern line of West Seneca Turnpike, the following 2 courses and distances, as measured along the northern line of West Seneca Turnpike, from the westerly line of South Salina Street: (1) S 87° 07' 10" W, 44.31 feet, (2) N 80° 12' 50" W 187.27 feet, said beginning point also being the southwestern corner of premises now or formerly owned by Motel GI Corporation.

thence N 80° 12' 50" W along the northern line of West Seneca Turnpike, a distance of 626.30 feet to the northeastern corner of premises owned by the City of Syracuse.

thence N 10° 53' 03" W along the westerly line of premises owned by the City of Syracuse, a distance of 118.85 feet to a point in the south line of the Selsey Tract abandoned roadway on said Selsey Tract as shown on a map made by G. E. Higgins and filed in the Onondaga County Clerk's Office June 7, 1897.

thence N 87° 31' 58" E along the extended line of the Selsey Tract and the southerly line of said Selsey Tract, a distance of 850.71 feet to a point.

thence S 2° 41' 10" E, a distance of 130.43 feet to a point in the northeastern corner of premises now or formerly owned by Motel GI Corporation.

thence S 12° 48' 21" W along the westerly line of said lots now or formerly owned by Motel GI Corporation, a distance of 94.77 feet to an angle in said westerly line.

thence S 2° 18' 40" E measured still along the westerly line of premises now or formerly owned by Motel GI Corporation, a distance of 32.87 feet measured to the point of beginning.

Notes:

All field measurements matched record dimensions within the precision requirements of ALTA/ACSM specifications unless otherwise shown.

All utility services are assumed to be underground unless otherwise shown.

No observable evidence of earth moving work, building construction, or building additions within recent months.

No observable evidence of recent street or sidewalk construction repairs or proposed changes in street right of way.

No observable evidence of site use as a solid waste dump, sump or sanitary landfill.

No observable evidence cemeteries, gravesites and burial grounds.

There were no wetlands delineated on the property.

No documents were provided for orbite assessment or servitudes.

The Property has vehicular and pedestrian access to West Seneca Turnpike - N.Y.S. Rte 173, a public right of way.

Property is served by Public Sanitary & Storm Sewers & Water.

Private Services that are available are electric, gas, telephone and cable TV.

Encroachments

Encroachment (A)
Adjacent owners building encroaches up to 1.47' onto parcel.

Encroachment (B)
Adjacent owners tennis encroaches up to 13.6' onto parcel.

Encroachment (C)
Adjacent owners shed encroaches up to 0.95' onto parcel.

No agreements have been executed.

Parking Requirement Variance

Parking Requirement - 1 Space per Dwelling Unit
Existing Dwelling Units - 124
Required Parking Spaces - 124
Per City of Syracuse Resolution # SP-72-17, 12/15/73
only 42 Parking Spaces will be required.

Zoning

Parcel Zoned RB (Residential Class B)

Front Yard Setback - 10' Minimum, any building over 2 stories must provide an additional 2' for every additional story.

Side Yard Setback - 4' Minimum, any building over 2 stories must provide an additional 2' for every additional story.

Rear Yard Setback - 20' Minimum, any building over 2 stories must provide an additional 2' for every additional story.

Building Lot Coverage - 40% Maximum for Multiple Family Dwelling
Parking Lot Coverage - 40% Maximum
Minimum Lot Width - 40'
Minimum Lot Area - 1000 Sq. Ft. per Family Dwelling
Parking Requirement - 1 Space per Dwelling Unit
Garages and Accessory Buildings - 4' minimum rear and side setback, except in the case of a corner lot, the street minimum offset shall be used. Shall not be located within front yard required for principal building.

Items Corresponding to Schedule B per Chicago Title Insurance Company Commitment No. 1417-39052 Dated 8/14/2015

11. Easement and Memorandum of Agreement granted to Time Warner Entertainment-Jobson/Residence Partnership by instrument dated March 29, 2000, and recorded in the Onondaga County Clerk's Office on April 21, 2000, in Liber 4411 of Deeds, at page 250. Affects Lot-Blanket in Nature.

12. Terms, covenants, and conditions set forth in that certain Memorandum of Lease dated as of April 13, 2001 by and between Valley Vista Apartments, L.P., Lessor, and Hotel 90 Lease Corp., d/b/a Hotel Partners, Lessee, a memorandum of which was recorded September 26, 2001 in Liber 4906 at page 25. Affects Lot-Blanket in Nature.

The underground utilities shown have been located from field survey information and existing drawings. The surveyor makes no guarantee that the underground utilities shown comprise all such utilities in the area other in service or abandoned. The surveyor further does not warrant that the underground utilities shown are in the exact location indicated although he does certify that they are located as accurately as possible from information available. The surveyor has not physically located the underground utilities - Underground Facilities Protective Organization (315) 437-7333.



Vicinity Map - Not to Scale

ALTA/ACSM Land Title Survey
Pt of the City of Syracuse
Onondaga Co., N.Y.

Scale 1" = 40'
D. W. HANNIG L.S., P.C.
SURVEYORS - PLANNERS - CONSULTANTS
THE MARKET PLACE BUILDING #1
MARKET PLACE, SYRACUSE, N.Y. 13202
PHONE: (315) 462-0221 FAX: (315) 462-1774

The undersigned, being a Registered Land Surveyor of the State of New York certified to: Valley Vista Holdings, Inc. Valley Vista LLC, its successors and assigns, Valley Vista Holding Development Fund Corp., New York State Bridge Finance Agency, JPMorgan Chase Bank, N.A., State of New York Mortgage Agency, their respective successors and/or assigns, South Salina Institutional Tax Credit RLLP, Limited Partnership, a Massachusetts limited partnership, their successors and assigns, BSM Capital Limited Partner, Inc., a Florida corporation, that entities, successors and assigns, Chicago Title Insurance Company and Common Hayman & Wells, LLP.

As follows:

This is to certify that this map or plan and the survey on which it is based were made in accordance with the 2001 Minimum Standards Detail Requirements for ALTA/ACSM Land Title Surveys, duly established and adopted by ALTA and NSPS, and include Items 1-10b, 11c, 12(a)(3), 13, 14, 15, 16, 17, 18, 19, 20, 21 and 22 of Table A hereof. The field work was completed on 8/04/15.

Date of Plot or Map: 10/28/15

David W. Hannig, L.S.
Registration/Expiration Number: 037411


FLOOD NOTE: By graphic plotting only, this property is in Zone(s) AE of the Flood Insurance Rate Map, Community Panel No. 5712/06 and is not in a Special Flood Hazard Area. As shown on the FEMA Website (HTTP:MSC.FEMA.GOV). We have learned this community does currently participate in the program. No field surveying was performed to determine this zone and an elevation certificate may be needed to verify this determination or apply for a variance from the Federal Emergency Management Agency.

South Salina

P.O.C.

NOTES

1. CONTRACTOR SHALL FIELD VERIFY ALL DIMENSIONS.
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5701 SOUTH SANTA FE DRIVE
LITTLETON, CO 80120

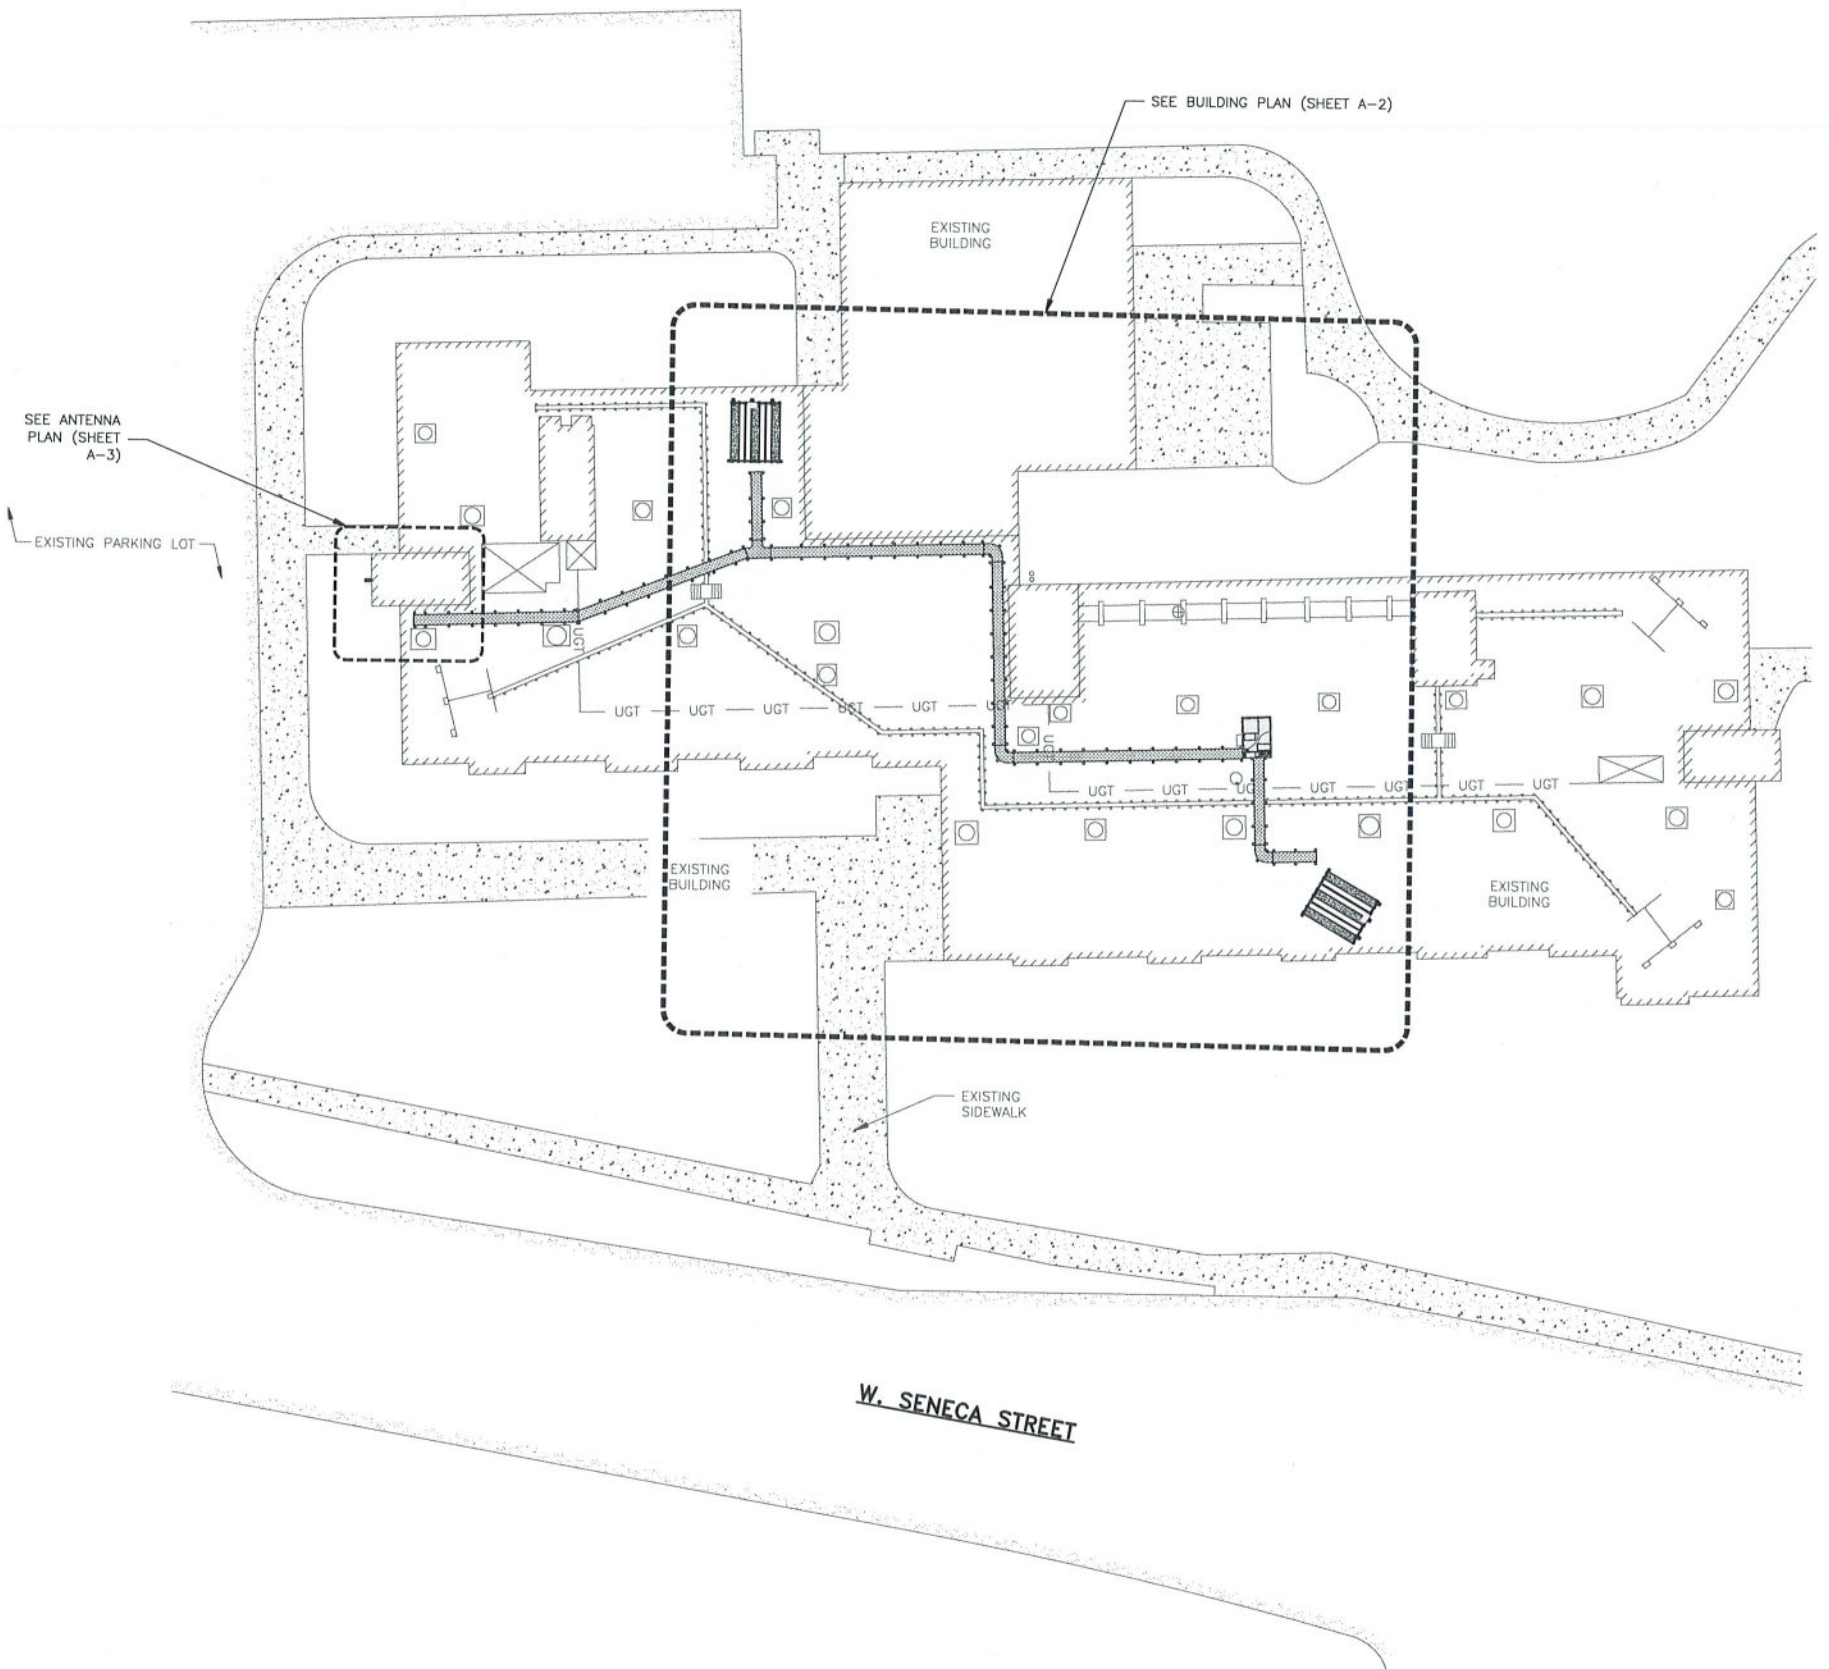

16 MIDDLE STREET, 4TH FLOOR
PORTLAND, ME 04101

Alec Scott Norris
NEW YORK LICENSED PROFESSIONAL ENGINEER
LICENSE NUMBER: 096835-1
COLLIERS ENGINEERING & DESIGN CT. P.C.
N.Y. C.O.A.#: 0017609

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DRAWN BY: AF CHECKED BY: DR APPROVED BY: MPC

RFDS REV #: 0

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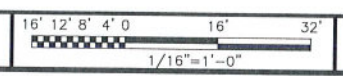
DISH Wireless L.L.C.
PROJECT INFORMATION
SYSR00355B
122 W. SENECA TURNPIKE
SYRACUSE, NY 13205

SHEET TITLE
OVERALL
SITE PLAN

SHEET NUMBER
A-1



OVERALL SITE PLAN





DISH Wireless L.L.C. SITE ID:
SYSYR00355B

DISH Wireless L.L.C. SITE ADDRESS:
**122 W. SENECA TURNPIKE
SYRACUSE, NY 13205**

SCOPE OF WORK

THIS IS NOT AN ALL INCLUSIVE LIST. CONTRACTOR SHALL UTILIZE SPECIFIED EQUIPMENT PART OR ENGINEER APPROVED EQUIVALENT. CONTRACTOR SHALL VERIFY ALL NEEDED EQUIPMENT TO PROVIDE A FUNCTIONAL SITE. THE PROJECT GENERALLY CONSISTS OF THE FOLLOWING:

- SECTOR SCOPE OF WORK:**
- INSTALL (3) PROPOSED PANEL ANTENNAS (1 PER SECTOR)
 - INSTALL (3) PROPOSED ANTENNA MOUNTS (1 PER SECTOR)
 - INSTALL PROPOSED JUMPERS
 - INSTALL (6) PROPOSED RRU's (2 PER SECTOR)
 - INSTALL (1) PROPOSED OVER VOLTAGE PROTECTION DEVICE (OVP)
 - INSTALL (3) PROPOSED HYBRID CABLE
 - INSTALL PROPOSED CABLE LADDER TRAY OR CABLE TRAY

- ROOFTOP SCOPE OF WORK:**
- INSTALL (1) PROPOSED METAL PLATFORM WITH H-FRAME
 - INSTALL (1) PROPOSED CABLE LADDER TRAY/INSTALL (1) PROPOSED BBU IN CABINET
 - INSTALL (1) PROPOSED EQUIPMENT CABINET
 - INSTALL (1) PROPOSED POWER CONDUIT
 - INSTALL (1) PROPOSED TELCO CONDUIT
 - INSTALL (1) PROPOSED NEMA 3 TELCO-FIBER BOX
 - INSTALL (1) PROPOSED GPS UNIT

SITE INFORMATION

PROPERTY OWNER: VALLEY VISTA, LLC
ADDRESS: 525 PLUM STREET
SYRACUSE, NY 13205

TOWER TYPE: ROOFTOP

TOWER CO SITE ID: N/A

TOWER APP NUMBER: N/A

COUNTY: ONONDAGA

LATITUDE (NAD 83): 43° 00' 04.3" N
43.001374 N

LONGITUDE (NAD 83): 76° 08' 39.8" W
76.144292 W

ZONING JURISDICTION: CITY OF SYRACUSE

ZONING DISTRICT: RESIDENTIAL - RB

PARCEL NUMBER: 071.-19-21.0

OCCUPANCY GROUP: U

CONSTRUCTION TYPE: V-B

POWER COMPANY: NATIONAL GRID

TELEPHONE COMPANY: VERIZON COMMUNICATIONS

PROJECT DIRECTORY

APPLICANT: DISH Wireless L.L.C.
5701 SOUTH SANTA FE DRIVE
LITTLETON, CO 80120

TOWER OWNER: VALLEY VISTA, LLC
525 PLUM STREET
SYRACUSE, NY 13205

SITE DESIGNER: TILSON
16 MIDDLE STREET, 4TH FLOOR
PORTLAND, ME 04101

SITE ACQUISITION: TBD

CONSTRUCTION MANAGER: TBD

RF ENGINEER: TBD



5701 SOUTH SANTA FE DRIVE
LITTLETON, CO 80120



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PROJECT INFORMATION
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122 W. SENECA TURNPIKE
SYRACUSE, NY 13205

SHEET TITLE
TITLE SHEET

SHEET NUMBER

T-1

NEW YORK CODE COMPLIANCE

ALL WORK SHALL BE PERFORMED AND MATERIALS INSTALLED IN ACCORDANCE WITH THE CURRENT EDITIONS OF THE FOLLOWING CODES AS ADOPTED BY THE LOCAL GOVERNING AUTHORITIES. NOTHING IN THESE PLANS IS TO BE CONSTRUED TO PERMIT WORK NOT CONFORMING TO THESE CODES:

CODE TYPE	CODE
BUILDING	2020 BUILDING CODE OF NYS, INCORPORATING THE 2018 IBC
MECHANICAL	2020 MECHANICAL CODE OF NYS, INCORPORATING THE 2018 IMC
ELECTRICAL	2017 NEC


SITE PHOTO



DIRECTIONS

DIRECTIONS FROM SYRACUSE HANCOCK INTERNATIONAL AIRPORT:
Head north on Col Eileen Collins Blvd toward Columbia Ln 1.5 mi. Take the ramp on the right for I-81 South and head toward Syracuse / Thruway 8.2 mi. At Exit 17, head right on the ramp for S State St toward S Salina St 0.2 mi. Keep straight to get onto McClure Ave 0.1 mi. Turn left onto US-11 S / S Salina St 1.5 mi. Turn right onto NY-173 / W Seneca Tpk 0.3 mi. Arrive at NY-173 / W Seneca Tpkex.

VICINITY MAP

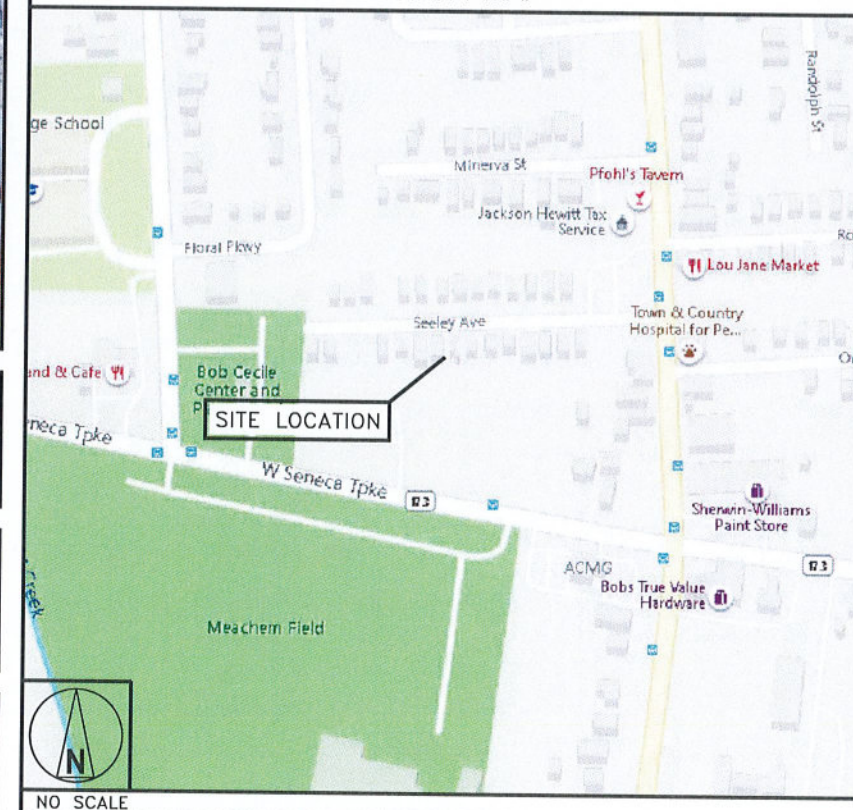

UNDERGROUND SERVICE ALERT - NEW YORK 811
UTILITY NOTIFICATION CENTER OF NEW YORK
(800) 272-4480
WWW.NEWYORK-811.COM



CALL 2 WORKING DAYS UTILITY NOTIFICATION PRIOR TO CONSTRUCTION

GENERAL NOTES


THE FACILITY IS UNMANNED AND NOT FOR HUMAN HABITATION. A TECHNICIAN WILL VISIT THE SITE AS REQUIRED FOR ROUTINE MAINTENANCE. THE PROJECT WILL NOT RESULT IN ANY SIGNIFICANT DISTURBANCE OR EFFECT ON DRAINAGE. NO SANITARY SEWER SERVICE, POTABLE WATER, OR TRASH DISPOSAL IS REQUIRED AND NO COMMERCIAL SIGNAGE IS PROPOSED.

11"x17" PLOT WILL BE HALF SCALE UNLESS OTHERWISE NOTED

CONTRACTOR SHALL VERIFY ALL PLANS, EXISTING DIMENSIONS, AND CONDITIONS ON THE JOB SITE, AND SHALL IMMEDIATELY NOTIFY THE ENGINEER IN WRITING OF ANY DISCREPANCIES BEFORE PROCEEDING WITH THE WORK.

SHEET INDEX

SHEET NO.	SHEET TITLE
T-1	TITLE SHEET
LS1	SITE SURVEY
A-1	OVERALL SITE PLAN
A-2	ENLARGED BUILDING PLAN
A-3	ANTENNA PLAN, ELEVATION AND SCHEDULE
A-4	NORTH AND SOUTH ELEVATIONS
A-5	EAST AND WEST ELEVATIONS
A-6	EQUIPMENT PLATFORM AND H-FRAME DETAILS
A-7	EQUIPMENT DETAILS
A-8	EQUIPMENT DETAILS
A-9	EQUIPMENT DETAILS
E-1	ELECTRICAL/FIBER ROUTE PLAN AND NOTES
E-2	ELECTRICAL DETAILS
E-3	ELECTRICAL ONE-LINE, FAULT CALCS & PANEL SCHEDULE
G-1	GROUNDING PLANS AND NOTES
G-2	GROUNDING DETAILS
G-3	GROUNDING DETAILS
RF-1	RF CABLE COLOR CODE
GN-1	LEGEND AND ABBREVIATIONS
GN-2	GENERAL NOTES
GN-3	GENERAL NOTES
GN-4	GENERAL NOTES

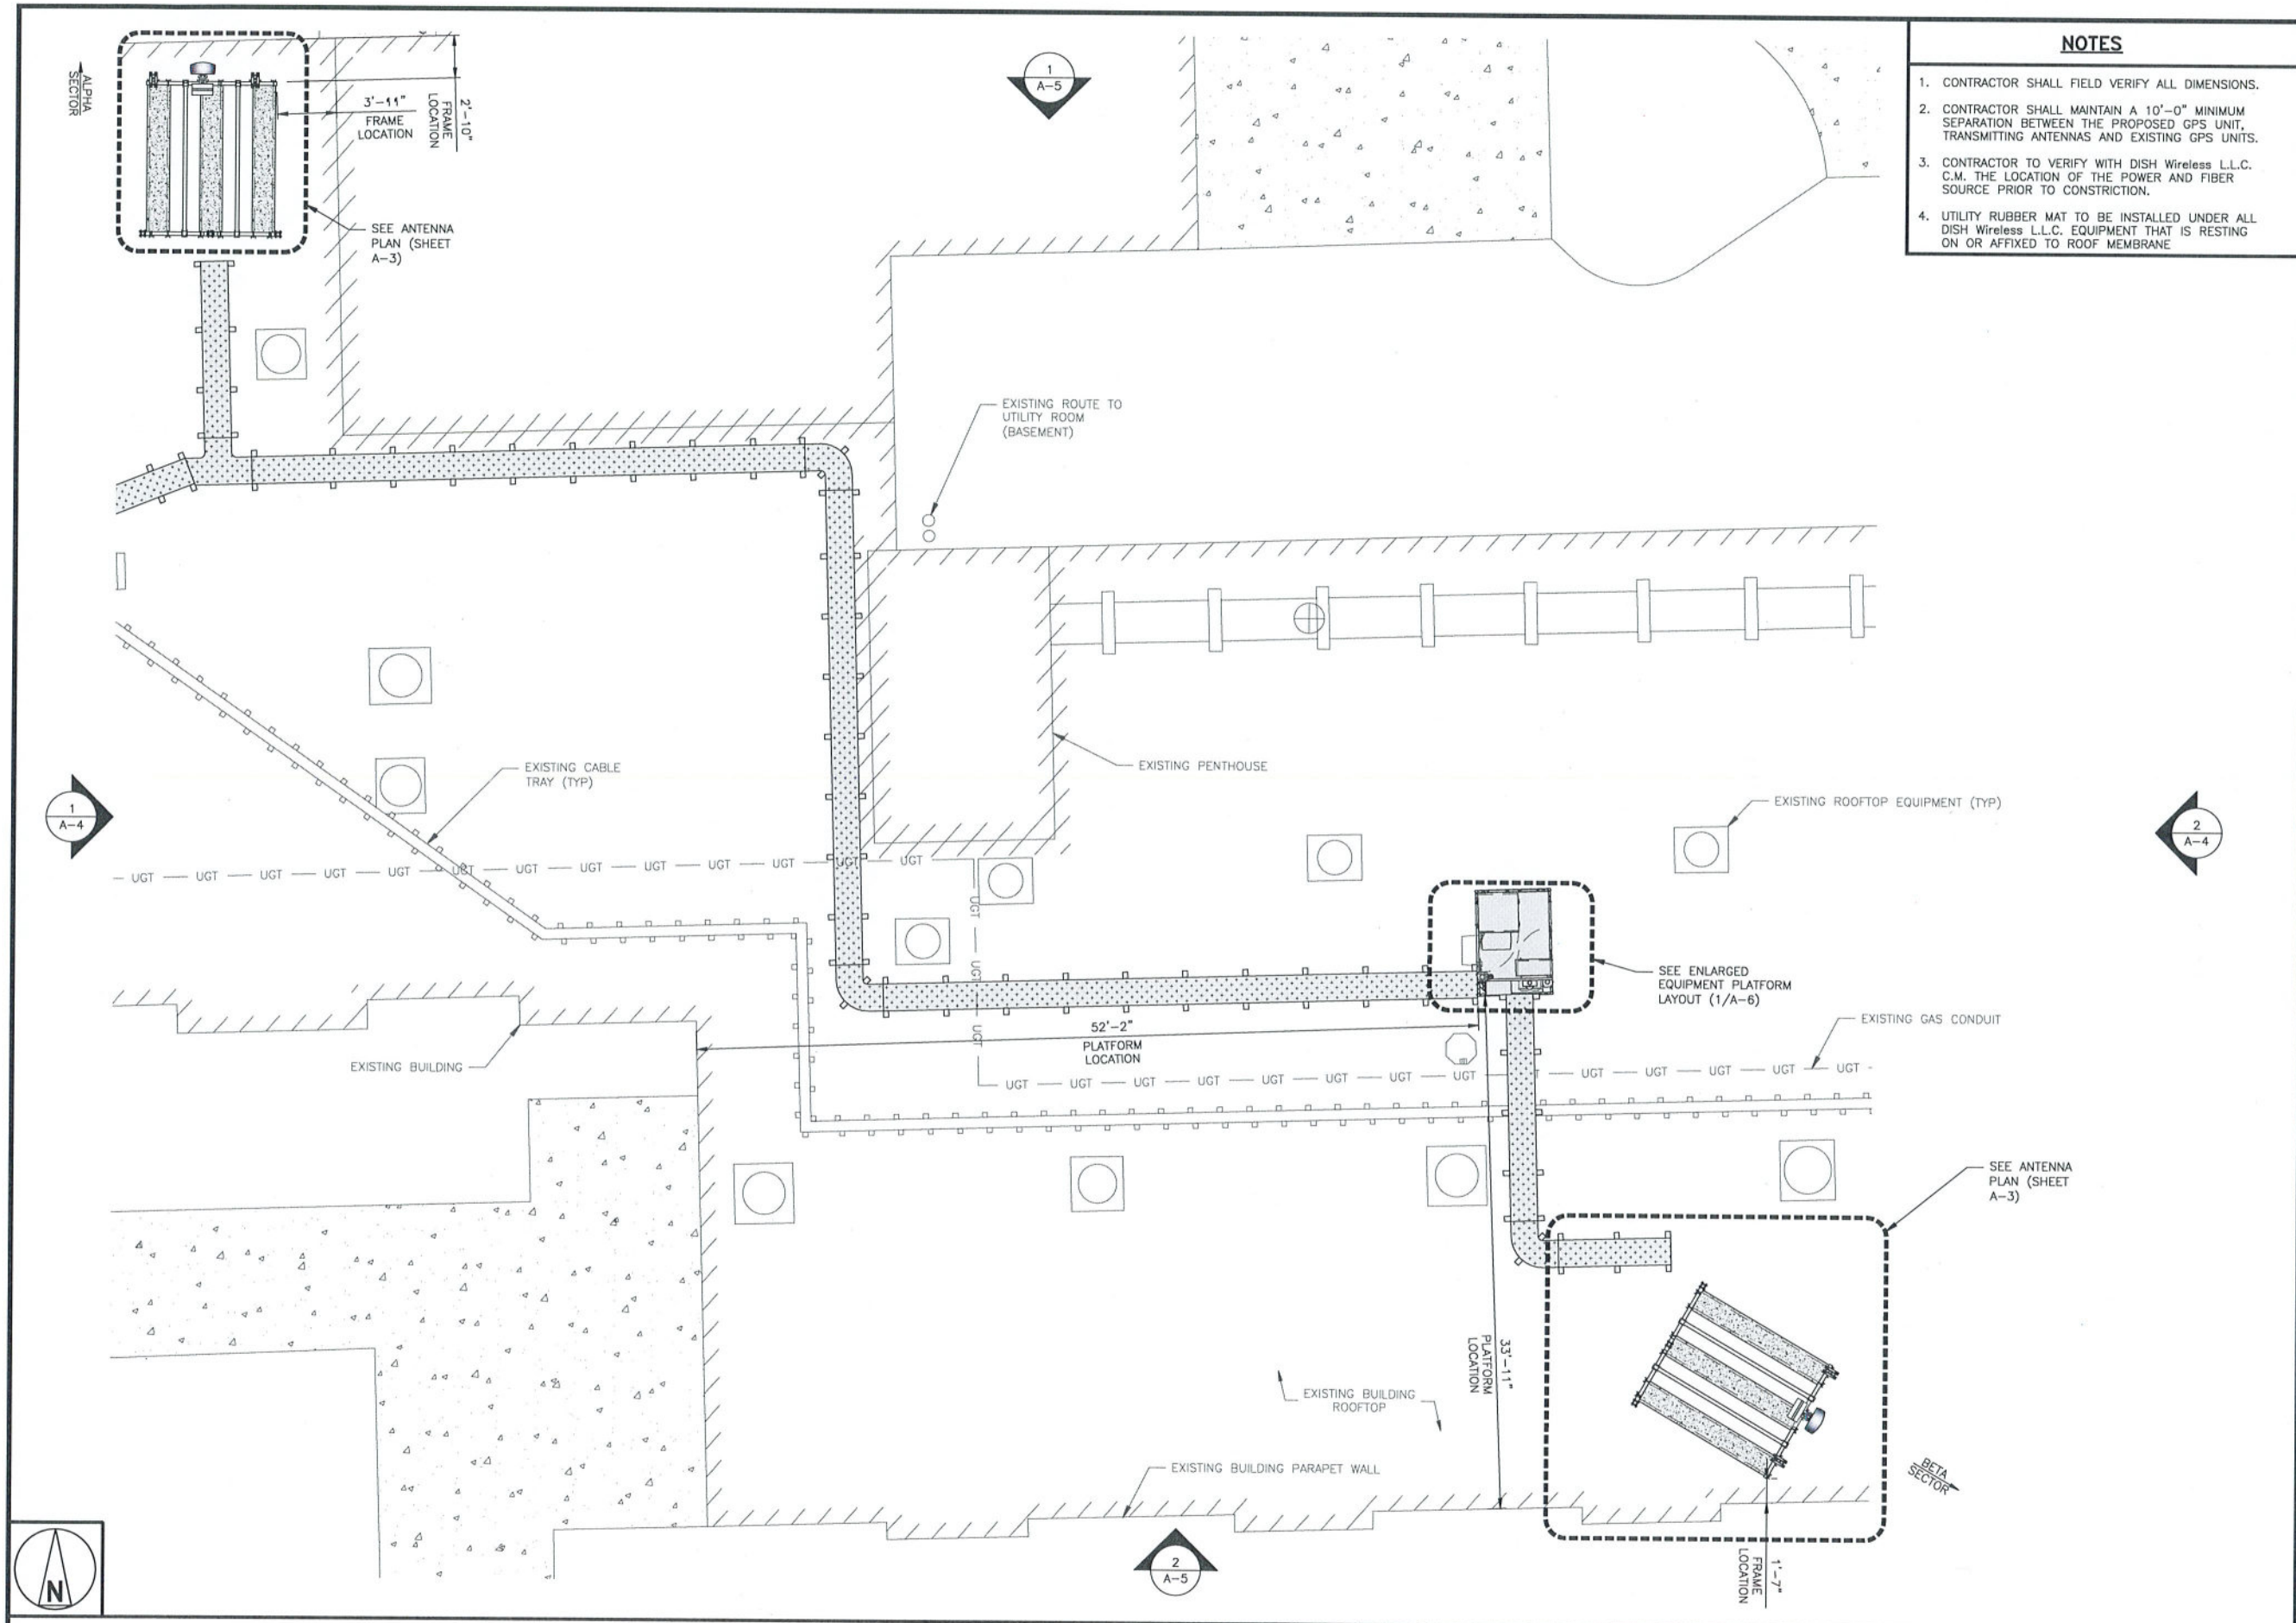

- NOTES**
1. CONTRACTOR SHALL FIELD VERIFY ALL DIMENSIONS.
 2. CONTRACTOR SHALL MAINTAIN A 10'-0" MINIMUM SEPARATION BETWEEN THE PROPOSED GPS UNIT, TRANSMITTING ANTENNAS AND EXISTING GPS UNITS.
 3. CONTRACTOR TO VERIFY WITH DISH Wireless L.L.C. C.M. THE LOCATION OF THE POWER AND FIBER SOURCE PRIOR TO CONSTRUCTION.
 4. UTILITY RUBBER MAT TO BE INSTALLED UNDER ALL DISH Wireless L.L.C. EQUIPMENT THAT IS RESTING ON OR AFFIXED TO ROOF MEMBRANE

dish wireless.

5701 SOUTH SANTA FE DRIVE
LITTLETON, CO 80120

TILSON
On a Mission

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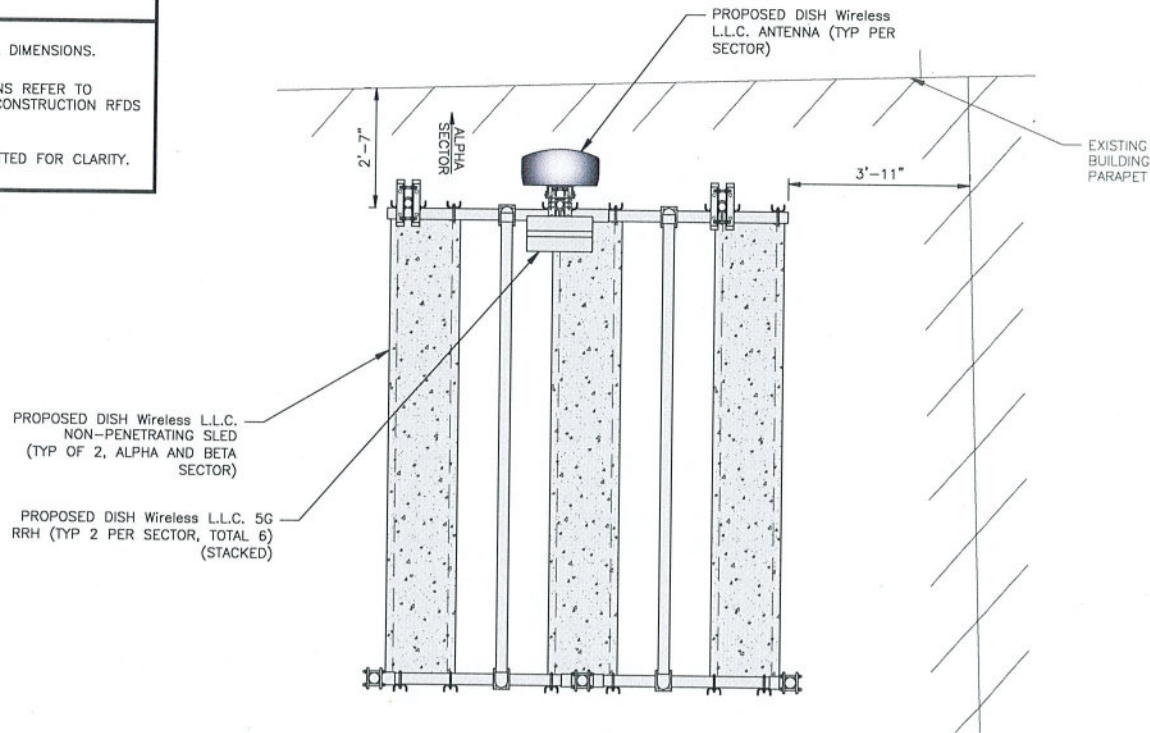
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SHEET TITLE
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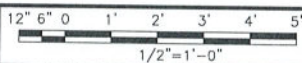
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A-2

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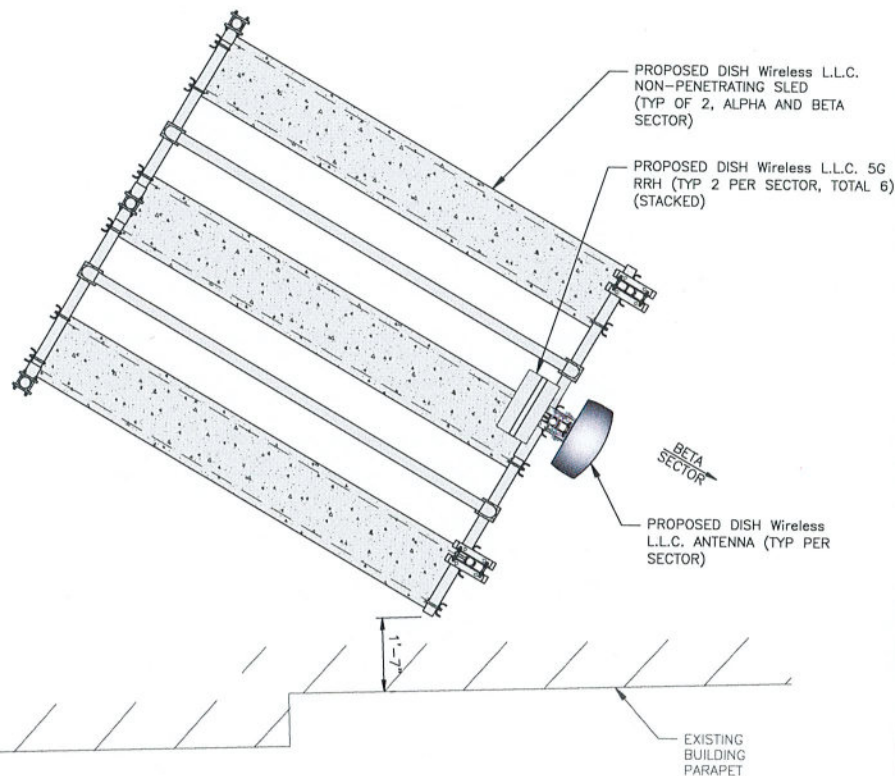
1. CONTRACTOR SHALL FIELD VERIFY ALL DIMENSIONS.
2. ANTENNA AND MW DISH SPECIFICATIONS REFER TO ANTENNA SCHEDULE AND TO FINAL CONSTRUCTION RFDS FOR ALL RF DETAILS
3. EXISTING EQUIPMENT AND FENCE OMITTED FOR CLARITY.




ANTENNA PLAN - ALPHA SECTOR




1



ANTENNA PLAN - BETA SECTOR

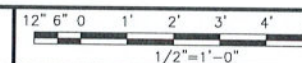

2

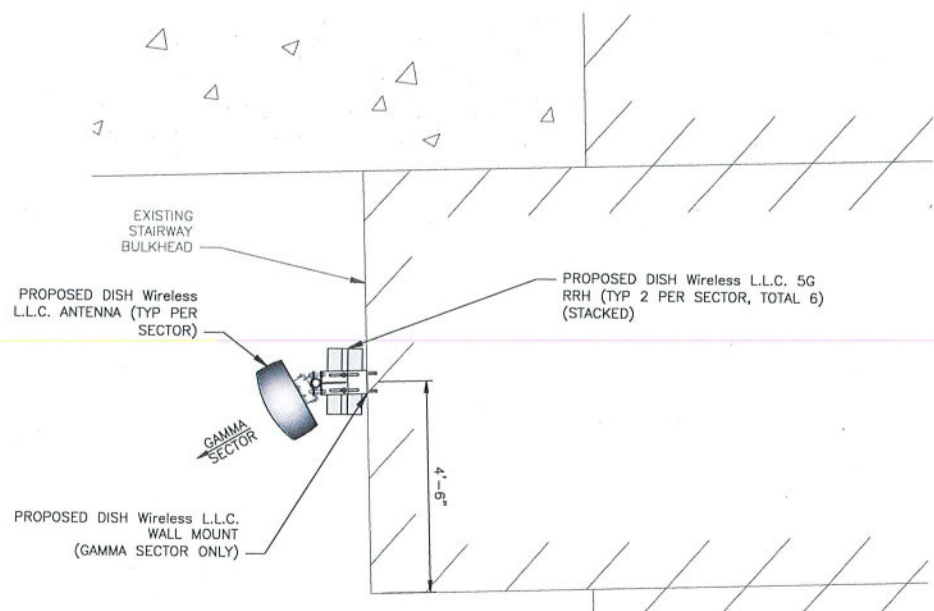

ANTENNA PLAN - GAMMA SECTOR



3

SECTOR	POSITION	ANTENNA						TRANSMISSION CABLE	
		EXISTING OR PROPOSED	MANUFACTURER - MODEL NUMBER	TECHNOLOGY	SIZE (HxW)	AZIMUTH	RAD CENTER	FEED LINE TYPE AND LENGTH	
ALPHA	A1	PROPOSED	JMA - MX08FRO665-20	5G	72.8" x 20.0"	0°	68"-10"	(1) HYBRID CABLE (150' LONG)	
BETA	B1	PROPOSED	JMA - MX08FRO665-20	5G	72.8" x 20.0"	120°	68"-10"	(1) HYBRID CABLE (50' LONG)	
GAMMA	C1	PROPOSED	JMA - MX08FRO665-20	5G	72.8" x 20.0"	240°	68"-10"	(1) HYBRID CABLE (75' LONG)	

SECTOR	POSITION	RRH		NOTES
		MANUFACTURER - MODEL NUMBER	TECHNOLOGY	
ALPHA	A1	FUJITSU - TA08025-B605	5G	1. CONTRACTOR TO REFER TO FINAL CONSTRUCTION RFDS FOR ALL RF DETAILS. 2. ANTENNA AND RRH MODELS MAY CHANGE DUE TO EQUIPMENT AVAILABILITY. ALL EQUIPMENT CHANGES MUST BE APPROVED AND REMAIN IN COMPLIANCE WITH THE PROPOSED DESIGN AND STRUCTURAL ANALYSES.
	A1	FUJITSU - TA08025-B604	5G	
BETA	B1	FUJITSU - TA08025-B605	5G	
	B1	FUJITSU - TA08025-B604	5G	
GAMMA	C1	FUJITSU - TA08025-B605	5G	
	C1	FUJITSU - TA08025-B604	5G	

ANTENNA SCHEDULE

NO SCALE

4

dish
wireless.

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AF DR MPC

RFDS REV #: 0

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SYRACUSE, NY 13205

SHEET TITLE
ANTENNA PLAN,
ELEVATION AND SCHEDULE

SHEET NUMBER

A-3

(1) PROPOSED DISH Wireless L.L.C. ANTENNA (TYPICAL PER SECTOR, TOTAL OF 3)
TOP OF ANTENNA @ 71'-10" AGL

(1) PROPOSED DISH Wireless L.L.C. ANTENNA (TYPICAL PER SECTOR, TOTAL OF 3)
RAD CENTER @ 68'-10" AGL

EXISTING BUILDING PARAPET
63'-10" AGL


EXISTING BUILDING ROOF
62'-10" AGL

PROPOSED DISH Wireless L.L.C. NON-PENETRATING SLED (ALPHA AND BETA SECTORS ONLY)

PROPOSED DISH Wireless L.L.C. 5G RRH (TYP 2 PER SECTOR, TOTAL 6) (STACKED)

PROPOSED DISH Wireless L.L.C. ANTENNA (TYP PER SECTOR)

EXISTING BUILDING

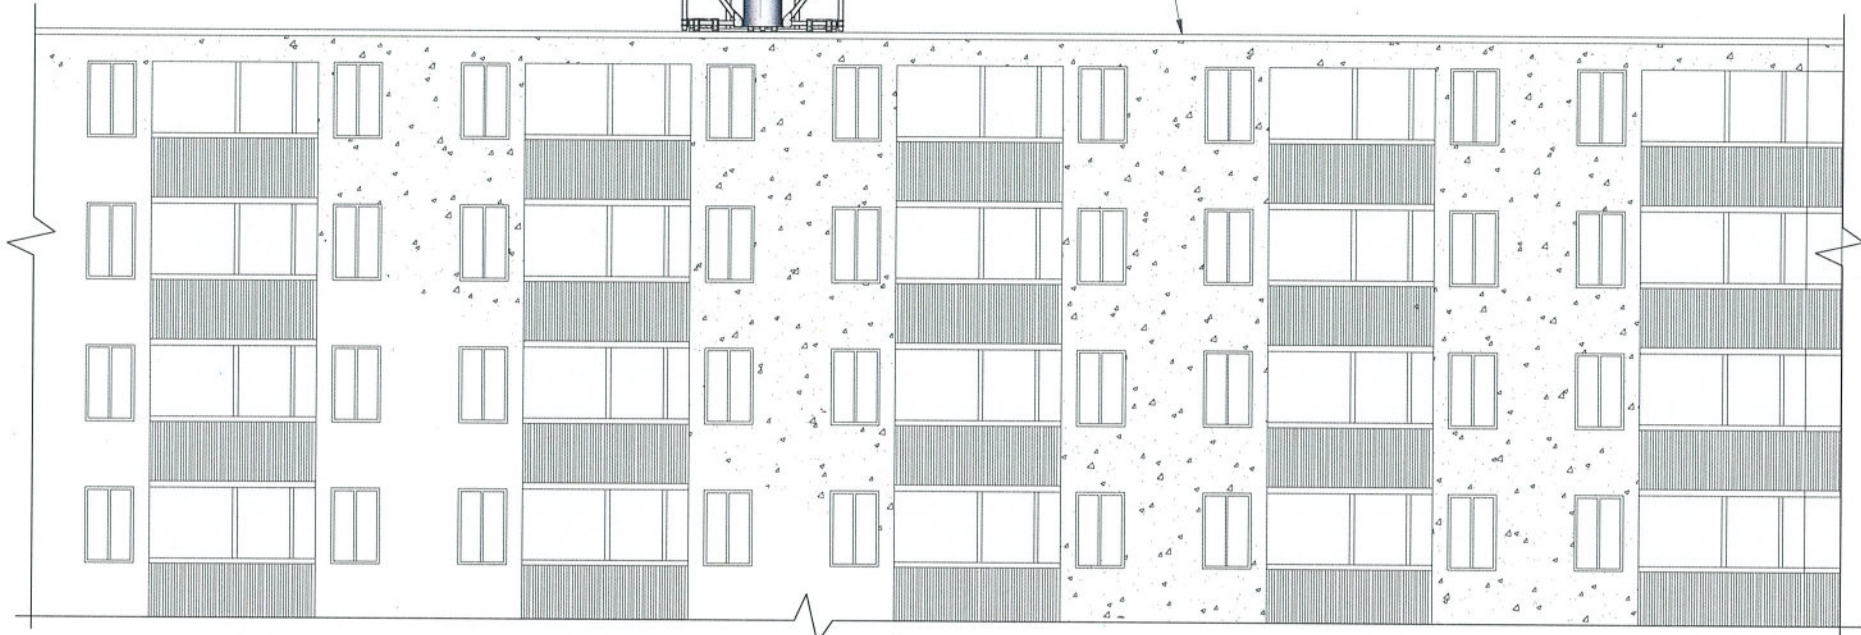

BUILDING NORTH ELEVATION

NOTES

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(1) PROPOSED DISH Wireless L.L.C. ANTENNA (TYPICAL PER SECTOR, TOTAL OF 3)
TOP OF ANTENNA @ 71'-10" AGL

(1) PROPOSED DISH Wireless L.L.C. ANTENNA (TYPICAL PER SECTOR, TOTAL OF 3)
RAD CENTER @ 68'-10" AGL

EXISTING BUILDING PARAPET
63'-10" AGL

EXISTING BUILDING ROOF
62'-10" AGL

PROPOSED DISH Wireless L.L.C. EQUIPMENT PLATFORM AND UTILITY H-FRAME

PROPOSED DISH Wireless L.L.C. EQUIPMENT CABINET

PROPOSED DISH Wireless L.L.C. NON-PENETRATING SLED (ALPHA AND BETA SECTORS ONLY)

PROPOSED DISH Wireless L.L.C. 5G RRH (TYP 2 PER SECTOR, TOTAL 6) (STACKED)

PROPOSED DISH Wireless L.L.C. ANTENNA (TYP PER SECTOR)

EXISTING EQUIPMENT PLATFORM (BY OTHERS)

EXISTING TALLEST BUILDING APPURTENANCE
72'-4" AGL



BUILDING SOUTH ELEVATION

NOTES

- CONTRACTOR SHALL FIELD VERIFY ALL DIMENSIONS.
- CONTRACTOR SHALL MAINTAIN A 10'-0" MINIMUM SEPARATION BETWEEN THE PROPOSED GPS UNIT, TRANSMITTING ANTENNAS AND EXISTING GPS UNITS.

EXISTING BULKHEAD

EXISTING PANEL ANTENNAS (BY OTHERS - TYP)

EXISTING BUILDING





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A	07/15/2021	ISSUED FOR REVIEW
0	08/11/2021	ISSUED FOR CONSTRUCTION


A&E PROJECT NUMBER
20933018A

DISH Wireless L.L.C. PROJECT INFORMATION
SYSYR00355B
122 W. SENECA TURNPIKE
SYRACUSE, NY 13205

SHEET TITLE
NORTH AND SOUTH ELEVATIONS

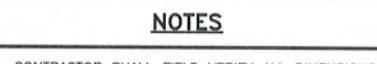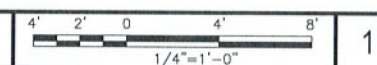SHEET NUMBER
A-4


- (1) PROPOSED DISH Wireless L.L.C. ANTENNA (TYPICAL PER SECTOR, TOTAL OF 3)
TOP OF ANTENNA @ 71'-10" AGL
- (1) PROPOSED DISH Wireless L.L.C. ANTENNA (TYPICAL PER SECTOR, TOTAL OF 3)
RAD CENTER @ 68'-10" AGL
- EXISTING BUILDING PARAPET
63'-10" AGL
- EXISTING BUILDING ROOF
62'-10" AGL

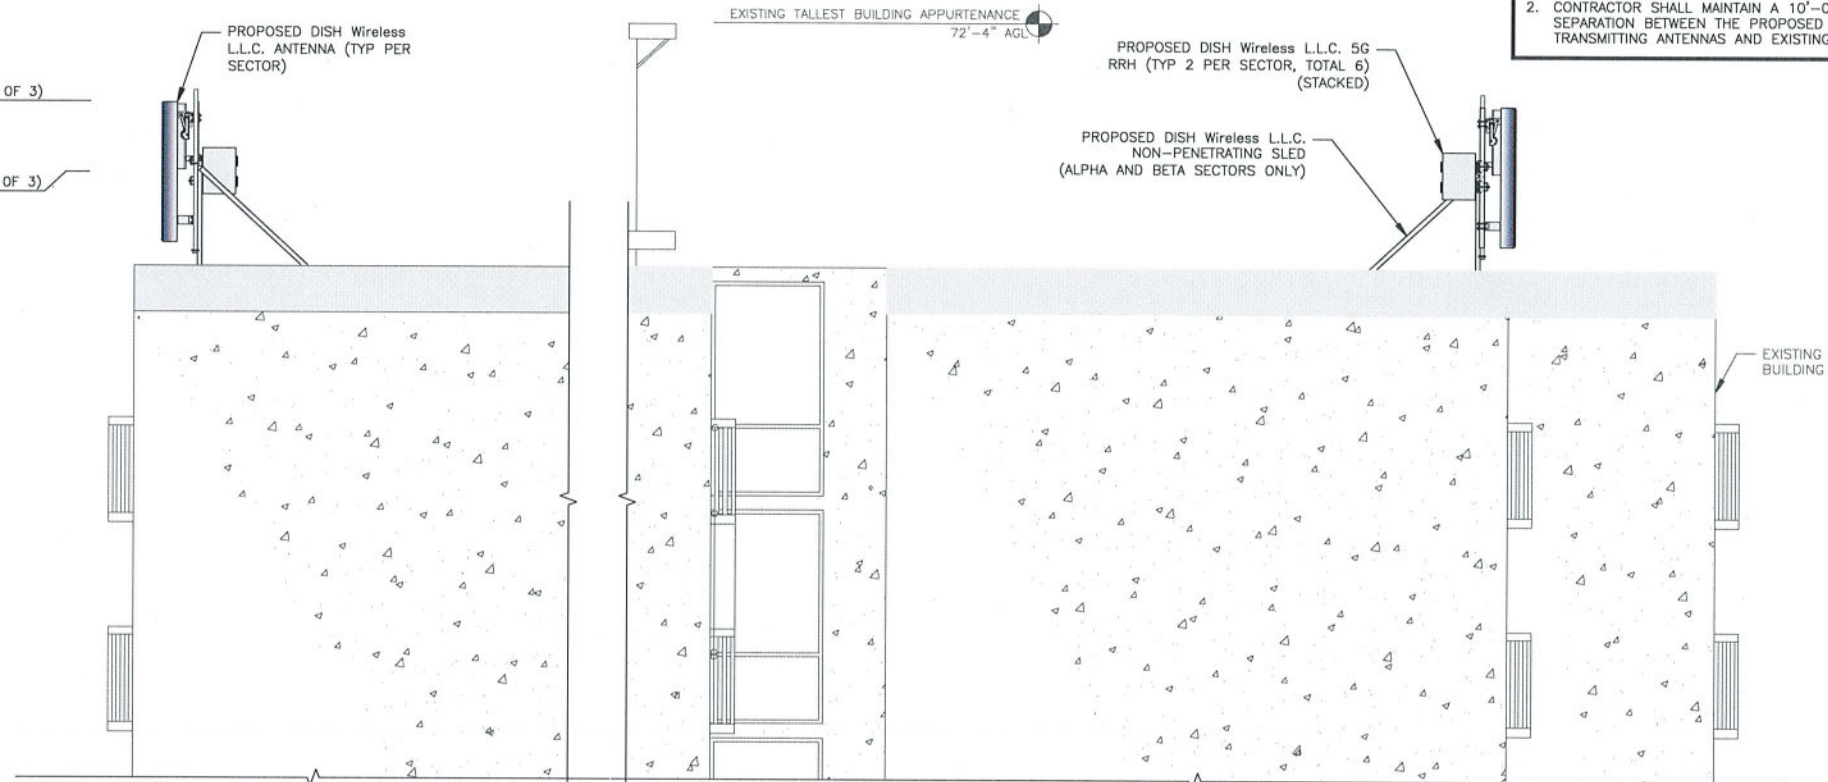

NOTES

1. CONTRACTOR SHALL FIELD VERIFY ALL DIMENSIONS.
2. CONTRACTOR SHALL MAINTAIN A 10'-0" MINIMUM SEPARATION BETWEEN THE PROPOSED GPS UNIT, TRANSMITTING ANTENNAS AND EXISTING GPS UNITS.

BUILDING EAST ELEVATION

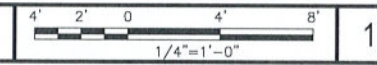

5701 SOUTH SANTA FE DRIVE
LITTLETON, CO 80120



16 MIDDLE STREET, 4TH FLOOR
PORTLAND, ME 04101

Alec Scott Norris
NEW YORK LICENSED PROFESSIONAL ENGINEER
LICENSE NUMBER: 096835-1
COLLIERS ENGINEERING & DESIGN CT, P.C.
N.Y. C.O.A.#: 0017609

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AF	DR	MPC

RFDS REV #: 0

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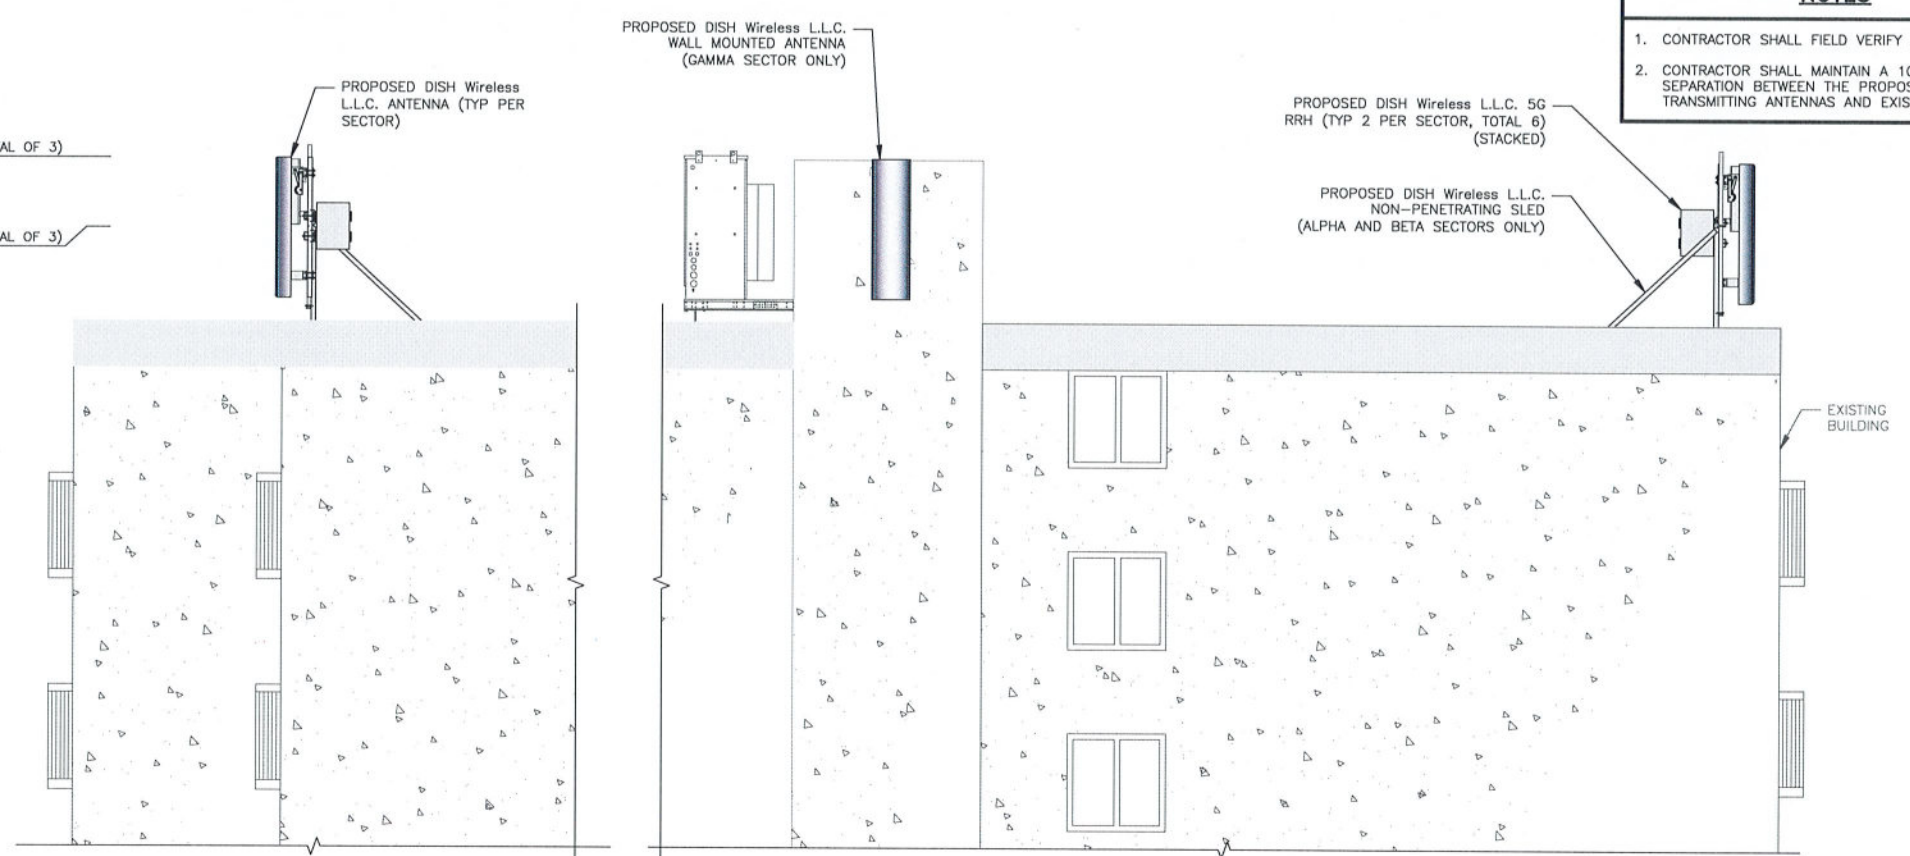
A&E PROJECT NUMBER
20933018A

DISH Wireless L.L.C.
PROJECT INFORMATION
SYSYR00355B
122 W. SENECA TURNPIKE
SYRACUSE, NY 13205

SHEET TITLE
EAST AND WEST ELEVATIONS

SHEET NUMBER
A-5


- (1) PROPOSED DISH Wireless L.L.C. ANTENNA (TYPICAL PER SECTOR, TOTAL OF 3)
TOP OF ANTENNA @ 71'-10" AGL
- (1) PROPOSED DISH Wireless L.L.C. ANTENNA (TYPICAL PER SECTOR, TOTAL OF 3)
RAD CENTER @ 68'-10" AGL
- EXISTING BUILDING PARAPET
63'-10" AGL
- EXISTING BUILDING ROOF
62'-10" AGL




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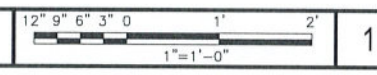
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BUILDING WEST ELEVATION



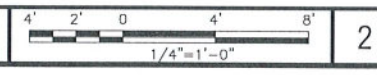

PLATFORM EQUIPMENT PLAN


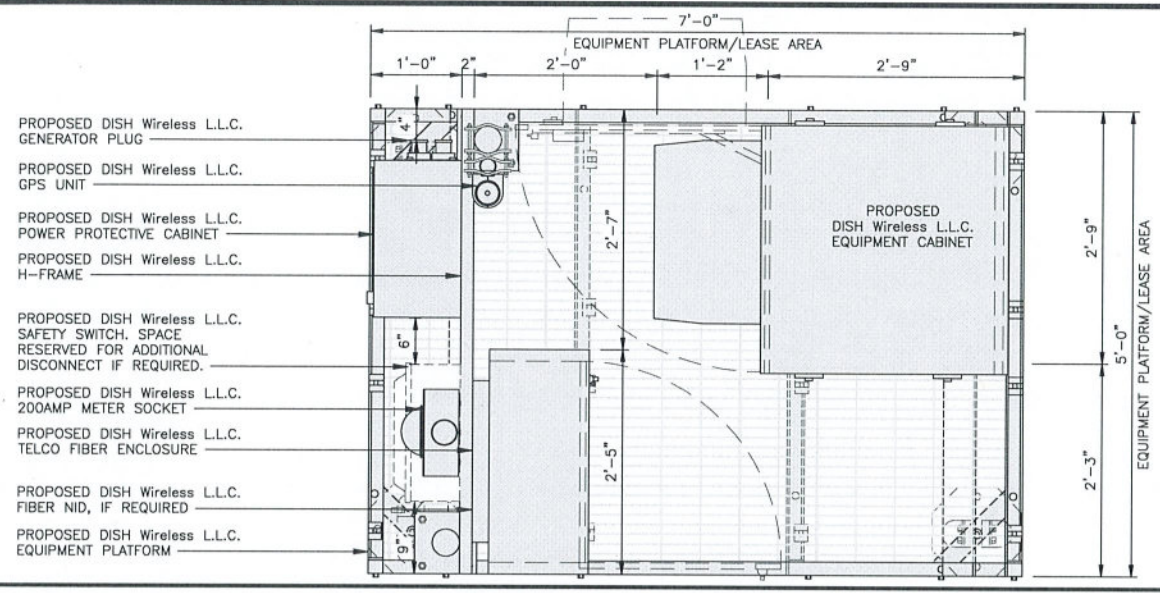


1

**COMMSCOPE MTC4045LP
5X7 PLATFORM**

DIMENSIONS (HxWxD)	16"x84"x60"
TOTAL WEIGHT	423 LBS

NOTE:
GC TO PROVIDE EXTENDED
THREAD FOR PLATFORM IF
REQUIRED HEIGHT EXCEEDS 17"

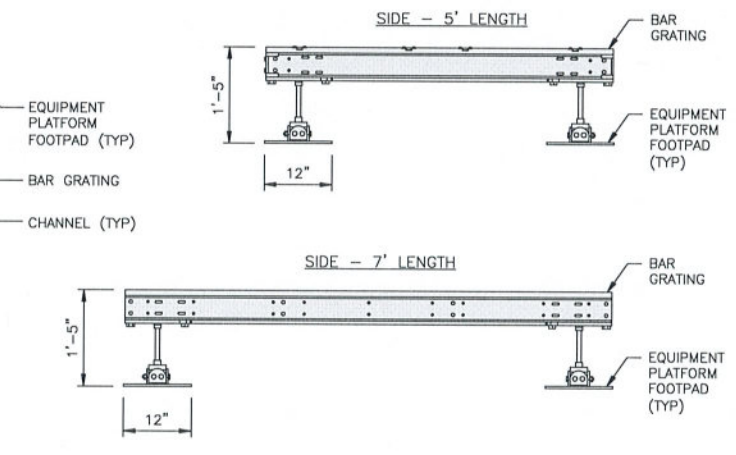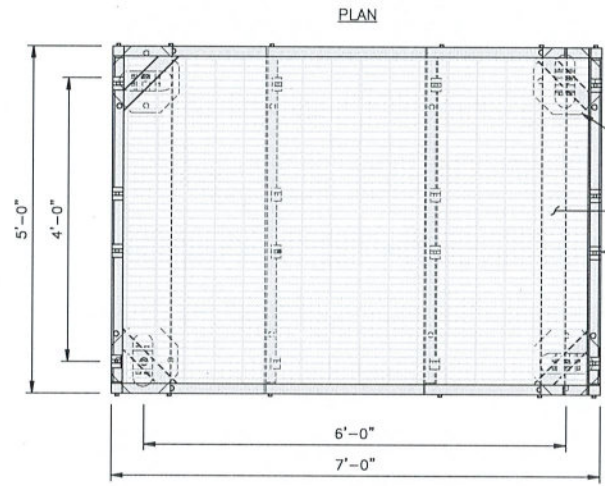



PLATFORM DETAIL

NO SCALE 2

**COMMSCOPE MTC4045HFLD
H-FRAME**

UNISTRUT/SUPPORT RAILS QTY	5
WEIGHT	59.74 lbs

NOTE:
OR DISH Wireless L.L.C.
APPROVED EQUIVALENT

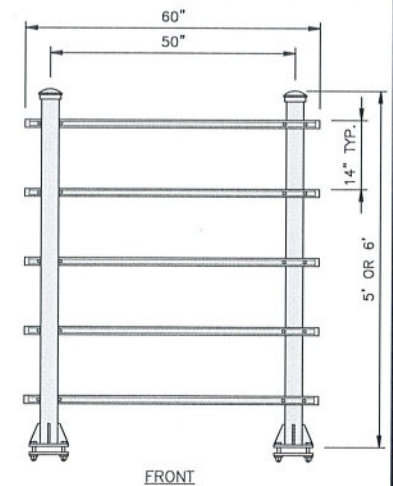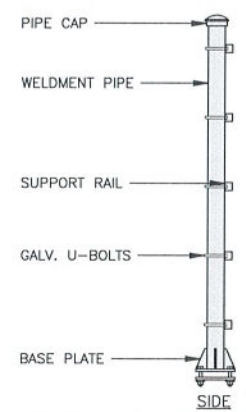


H-FRAME DETAIL

NO SCALE 3


NOT USED

NO SCALE 4

NOTE
1. EQUIPMENT CABINET OMITTED FOR CLARITY

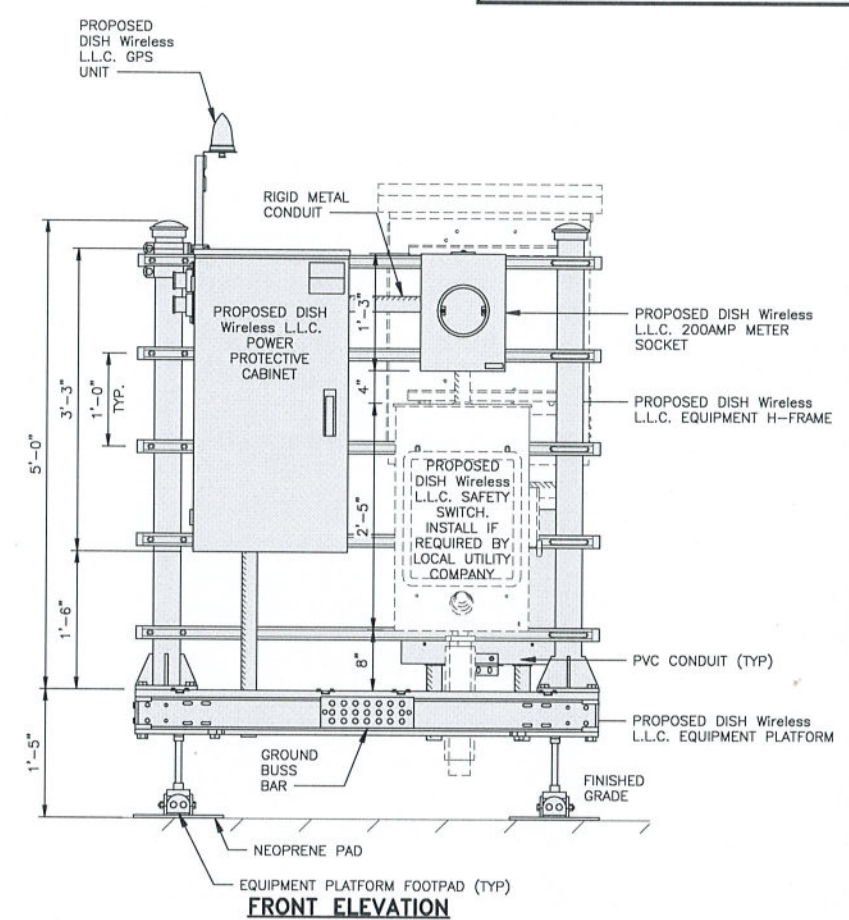


FRONT ELEVATION

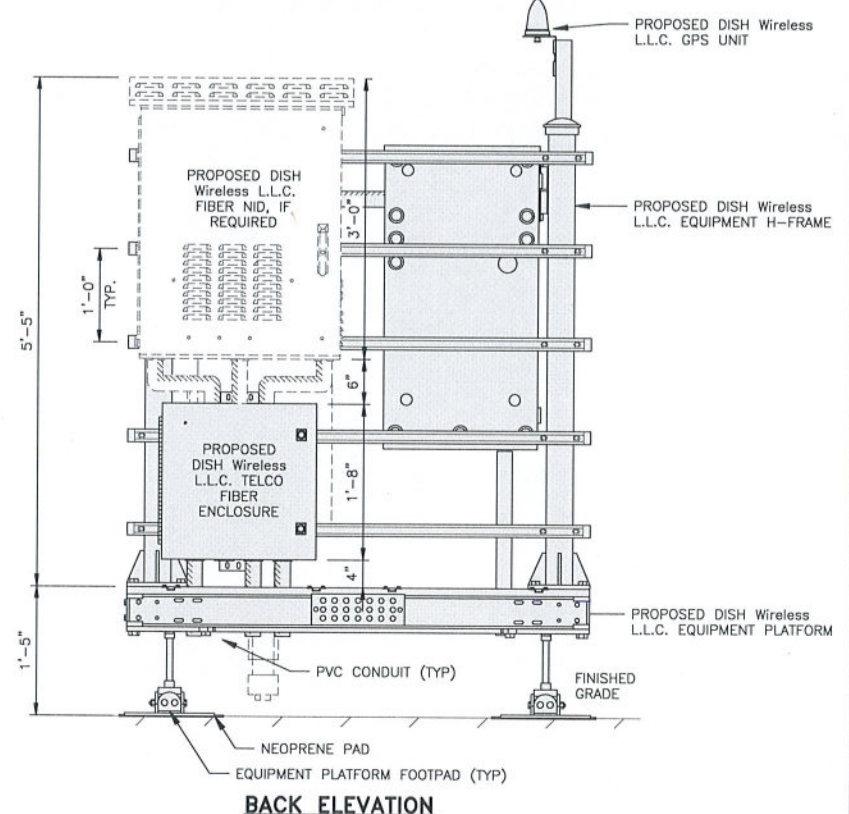

BACK ELEVATION

H-FRAME EQUIPMENT ELEVATION

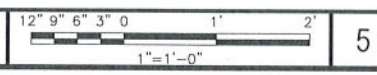

5



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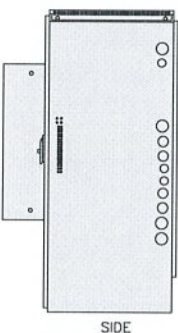
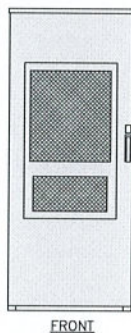
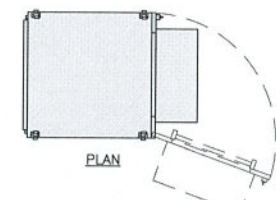
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DISH Wireless L.L.C.
PROJECT INFORMATION
SYSYR00355B
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SYRACUSE, NY 13205

SHEET TITLE
EQUIPMENT PLATFORM AND
H-FRAME DETAILS

SHEET NUMBER
A-6



ENERSYS HEX CABINET 200005996	
DIMENSIONS (HxWxD):	73"x30"x32"
WEIGHT EMPTY:	376 lbs
HEATER	800W
POWER SYSTEM	-48V ALPHA/600A



CABINET DETAIL

NO SCALE 1


SQUARE D SAFETY SWITCHES D224NRB	
ENCLOSURE DIM (HxWxD)	29.25"x19.00"x8.50"
ENCLOSURE TYPE	NEMA 3R RAINPROOF
UL LISTED	FILE E-2875

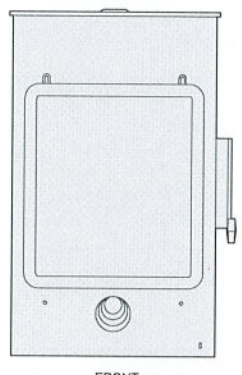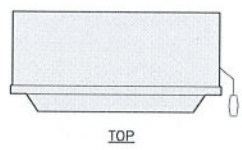

SAFETY SWITCH DETAIL

NO SCALE 2




GE BREAKER PANEL TLM1220RUCP	
ENCLOSURE DIM (HxWxD)	29"x13"x5"
TOTAL WEIGHT (EMPTY)	26 LBS
MAX VOLTAGE/MAX AMPS	240V/200A
ENCLOSURE RATING	OUTDOOR NEMA 3R

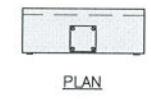

BREAKER PANEL DETAIL

NO SCALE 3



LEVITON 1N240-21 SUBMETER	
WATTAGE	3
AMPS	200
VOLTS AC	120, 208, 240
PHASE	1

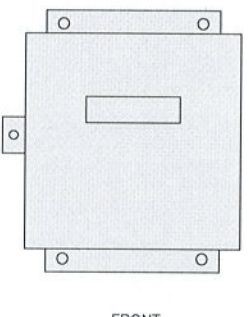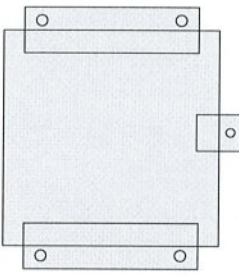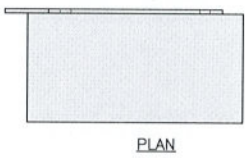

E-MON D-MON DETAIL


NO SCALE 4

PCTEL GPSGL-TMG-SPI-40NCB	
DIMENSIONS (DIAxH) MM/INCH	81x184mm 3.2"x7.25"
WEIGHT W/ACCESSORIES	075 lbs
CONNECTOR	N-FEMALE
FREQUENCY RANGE	1590 ± 30MHz

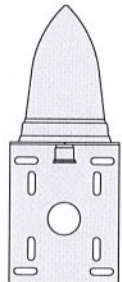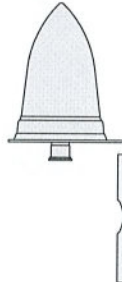


GPS DETAIL

NO SCALE 5

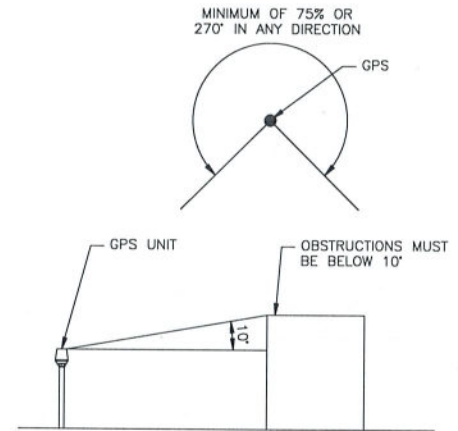

GPS MINIMUM SKY VIEW REQUIREMENTS





NO SCALE 6

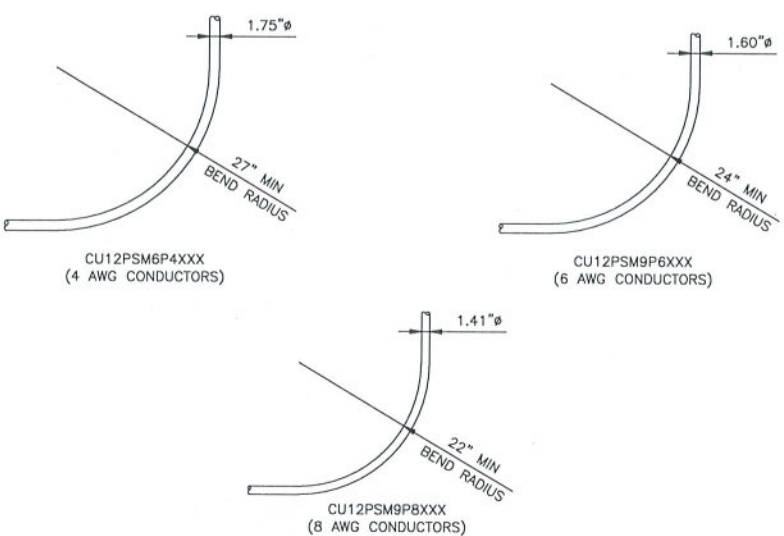

**CABLES UNLIMITED HYBRID CABLE
MINIMUM BEND RADIUS**

NO SCALE 7

CHARLES CFIT-PF2020DSH1 FIBER TELCO ENCLOSURE	
ENCLOSURE DIMS (HxWxD)	20"x20"x9"
ENCLOSURE WEIGHT	20 lbs
MOUNTING	WALL
COMPLIANCE	TYPE 4

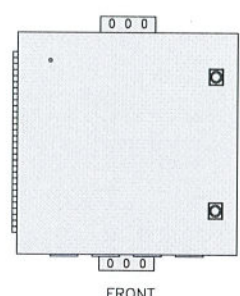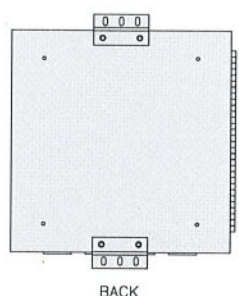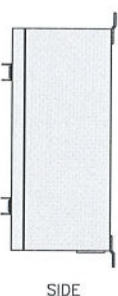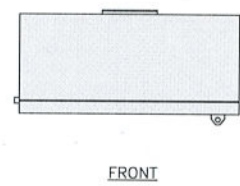


FIBER TELCO ENCLOSURE DETAIL

NO SCALE 8

COMMSCOPE MT-F1543 ROOFTOP CABLE BRIDGE KIT	
DIMENSIONS (HxWxD)	7"x30"x9"
WEIGHT	112.3 lbs
CABLE RUN, QUANTITY	8

NOTE: NON-PENETRATING, 12-GAUGE COVER, OR APPROVED EQUAL. INCLUDES: CHANNEL, HARDWARE AND (3) SLEEPERS

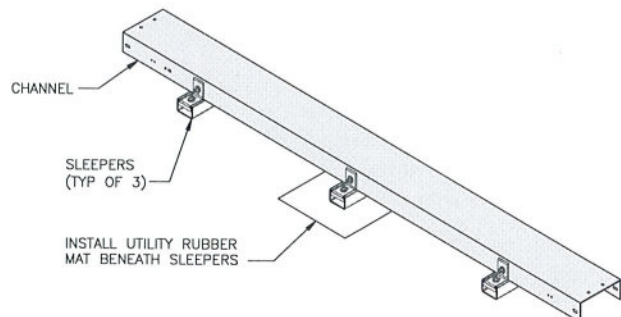

WALL MOUNTED CABLE TRAY DETAIL

NO SCALE 9



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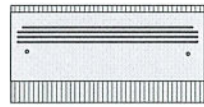
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DISH Wireless L.L.C.
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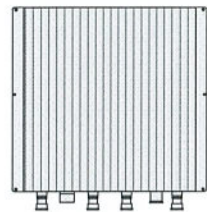
SHEET TITLE
EQUIPMENT DETAILS

SHEET NUMBER
A-7


FUJITSU DUAL BAND TA08025-B604	
DIMENSIONS (HxWxD)	14.9"x15.7"x7.8"
WEIGHT	63.9 lbs
CONNECTOR TYPE	4.3-10 RF CONNECTOR
POWER SUPPLY	DC -58~-36V




PLAN



BACK

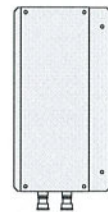


SIDE

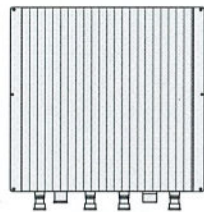


FRONT

FUJITSU TRIPLE BAND TA08025-B605	
DIMENSIONS (HxWxD)	14.9"x15.7"x9"
WEIGHT	74.95 lbs
CONNECTOR TYPE	4.3-10 RF CONNECTOR
POWER SUPPLY	DC -58~-36V

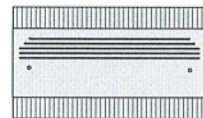


PLAN

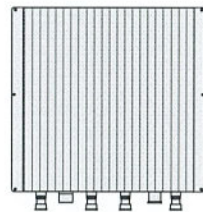

BACK



SIDE

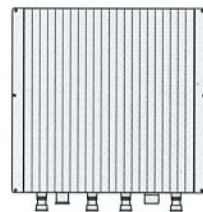

FRONT

RRH DETAIL

NO SCALE

1

RRH DETAIL

NO SCALE


2

NOT USED


NO SCALE

3


RAYCAP RDIC-4045-PF-48 SURGE PROTECTION DEVICE (OVP)	
DIMENSIONS (HxWxD)	14" x 16" x 8"
WEIGHT	21.85 LBS

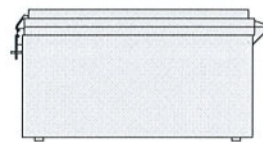


PLAN

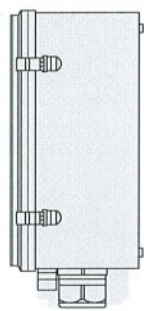

SIDE

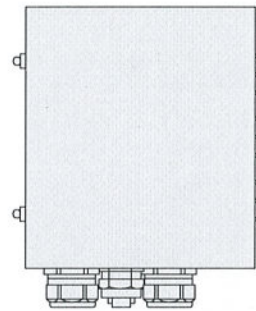

BACK

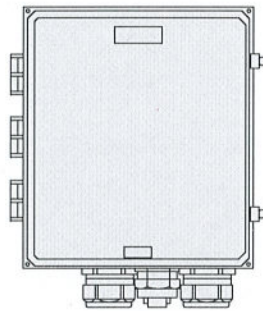


FRONT


JMA MX08FIT665-20	
UNISTRUT DIMENSIONS (HxWxL)	72.8" x 20.0" x 8.0"
WEIGHT W/O MOUNTING HARDWARE	64.5 LB
WEIGHT W/ MOUNTING HARDWARE	77.5 LB



PLAN

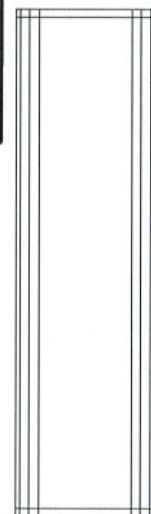


FRONT

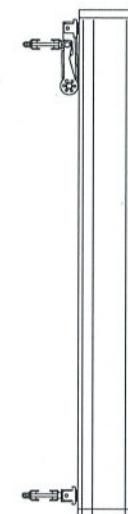

SIDE

UTILITY RUBBER MAT, BLACK

DIMENSIONS	4' x 3' x 1/2"
WEIGHT/ VOLUME	36.5 LB AVERAGE
MATERIAL	100% RECYCLE RUBBER

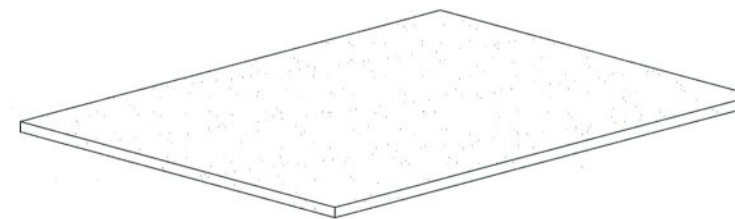

SURGE PROTECTION DEVICE DETAIL (OVP)

NO SCALE

4

ANTENNA DETAIL

NO SCALE


5

UTILITY RUBBER MAT DETAIL

NO SCALE

6

M04 MOUNTING BRACKET HPA-33R-BUU-H4-K	
WIDTH	5"
DEPTH	2"
HEIGHT	8"
TOTAL WEIGHT	1.5 lbs
HOUSING MATERIAL	ASA/ABS/ALUMINUM
RADOME COLOR	LIGHT GRAY
CONNECTOR	1x8-PIN DAISY CHAIN

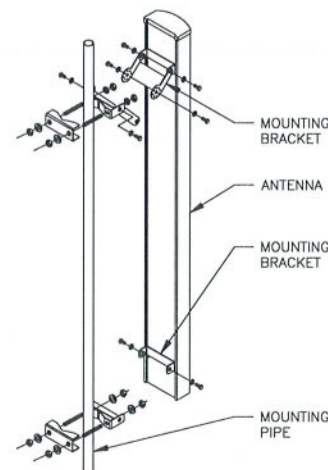

NOTE:
OR DISH Wireless L.L.C.
APPROVED EQUIVALENT

ANTENNA MOUNTING DETAIL


NO SCALE

7


DURA-BLOK DB10
ROOFTOP CABLE SUPPORT

DIMENSIONS (HxWxL)	5"x6"x9.6"
WEIGHT/ VOLUME	5.28 LBS
ULTIMATE LOAD CAPACITY	500 LBS


NOTE: NON-PENETRATING

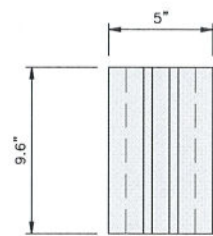

PLAN

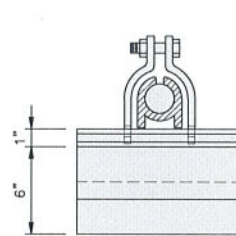

FRONT

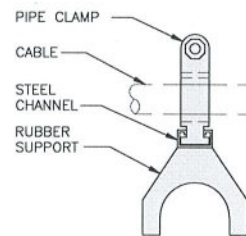

SIDE

ROOFTOP CABLE SUPPORT DETAIL


NO SCALE

8


SITEPRO1 CSRT-3-888
NON-PENETRATING 3-MAST TRAY

FACE SIZE	8'-0"
WEIGHT	844.27

NOTE:
CONCRETE BLOCKS (CMU), 4"x8"x16" or 8"x8"x16" ARE
TYPICALLY USED

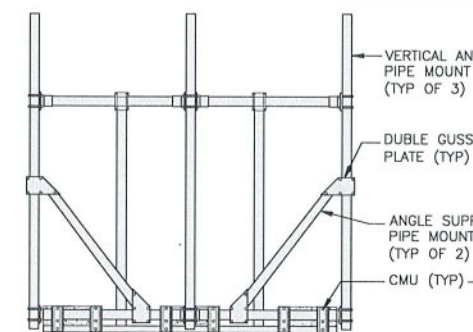

FRONT

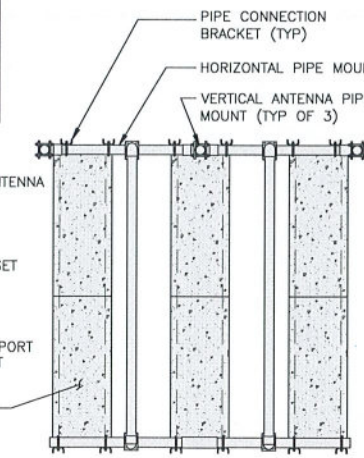

PLAN

ANTENNA FRAME DETAIL

NO SCALE

9

dish
wireless.

5701 SOUTH SANTA FE DRIVE
LITTLETON, CO 80120

TILSON
On a Mission

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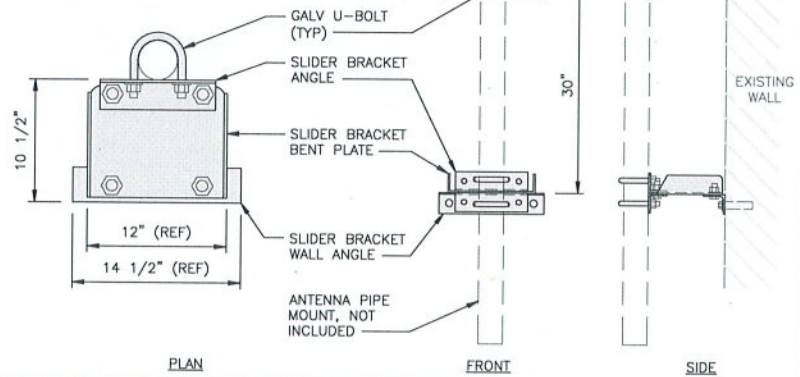
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EQUIPMENT DETAILS

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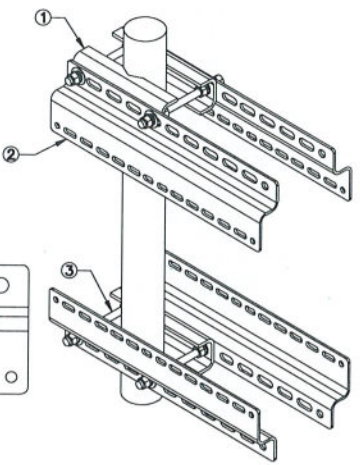
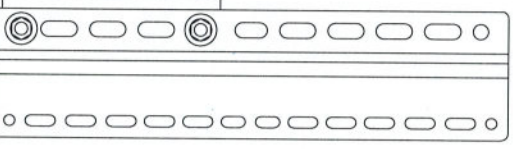
A-8

SITEPRO1 SBWM-HD SLIDER BRACKET WALL MOUNTS	
DIMENSIONS (WxD)	14.5" x 10.5"
WEIGHT	53.48 LB
ANTENNA PIPE SIZE	3.5" & 4.5" O.D.



SABRE DOUBLE Z-BRACKET C10123155	
DIMENSIONS (HxWxD) (1 BRACKET)	5"x20"x1-13/16"
WEIGHT (FULL ASSEMBLY)	35.79 lbs
PACKAGE QUANTITY	4

#	DESCRIPTION
1	PLATE, CHANNEL BRACKET
2	RRH Z BRACKET, 3/16"
3	THREADED ROD ASSEMBLY 1/2"x12"



NOTE:
OR DISH Wireless L.L.C.
APPROVED EQUIVALENT

ANTENNA WALL MOUNT DETAIL	NO SCALE	1	RRH MOUNT DETAIL	NO SCALE	2	NOT USED	NO SCALE	3
NOT USED	NO SCALE	4	NOT USED	NO SCALE	5	NOT USED	NO SCALE	6
NOT USED	NO SCALE	7	NOT USED	NO SCALE	8	NOT USED	NO SCALE	9

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wireless.

5701 SOUTH SANTA FE DRIVE
LITTLETON, CO 80120

TILSON
On a Mission

16 MIDDLE STREET, 4TH FLOOR
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Alec Scott Norris
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N.Y. C.O.A.#: 0017609

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AF	DR	MPC
RFDS REV #:		0

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A&E PROJECT NUMBER
20933018A

DISH Wireless L.L.C.
PROJECT INFORMATION

SYSYR00355B
122 W. SENECA TURNPIKE
SYRACUSE, NY 13205

SHEET TITLE
EQUIPMENT DETAILS

SHEET NUMBER
A-9

NOTE

CONTRACTOR SHALL FIELD VERIFY ALL DIMENSIONS.

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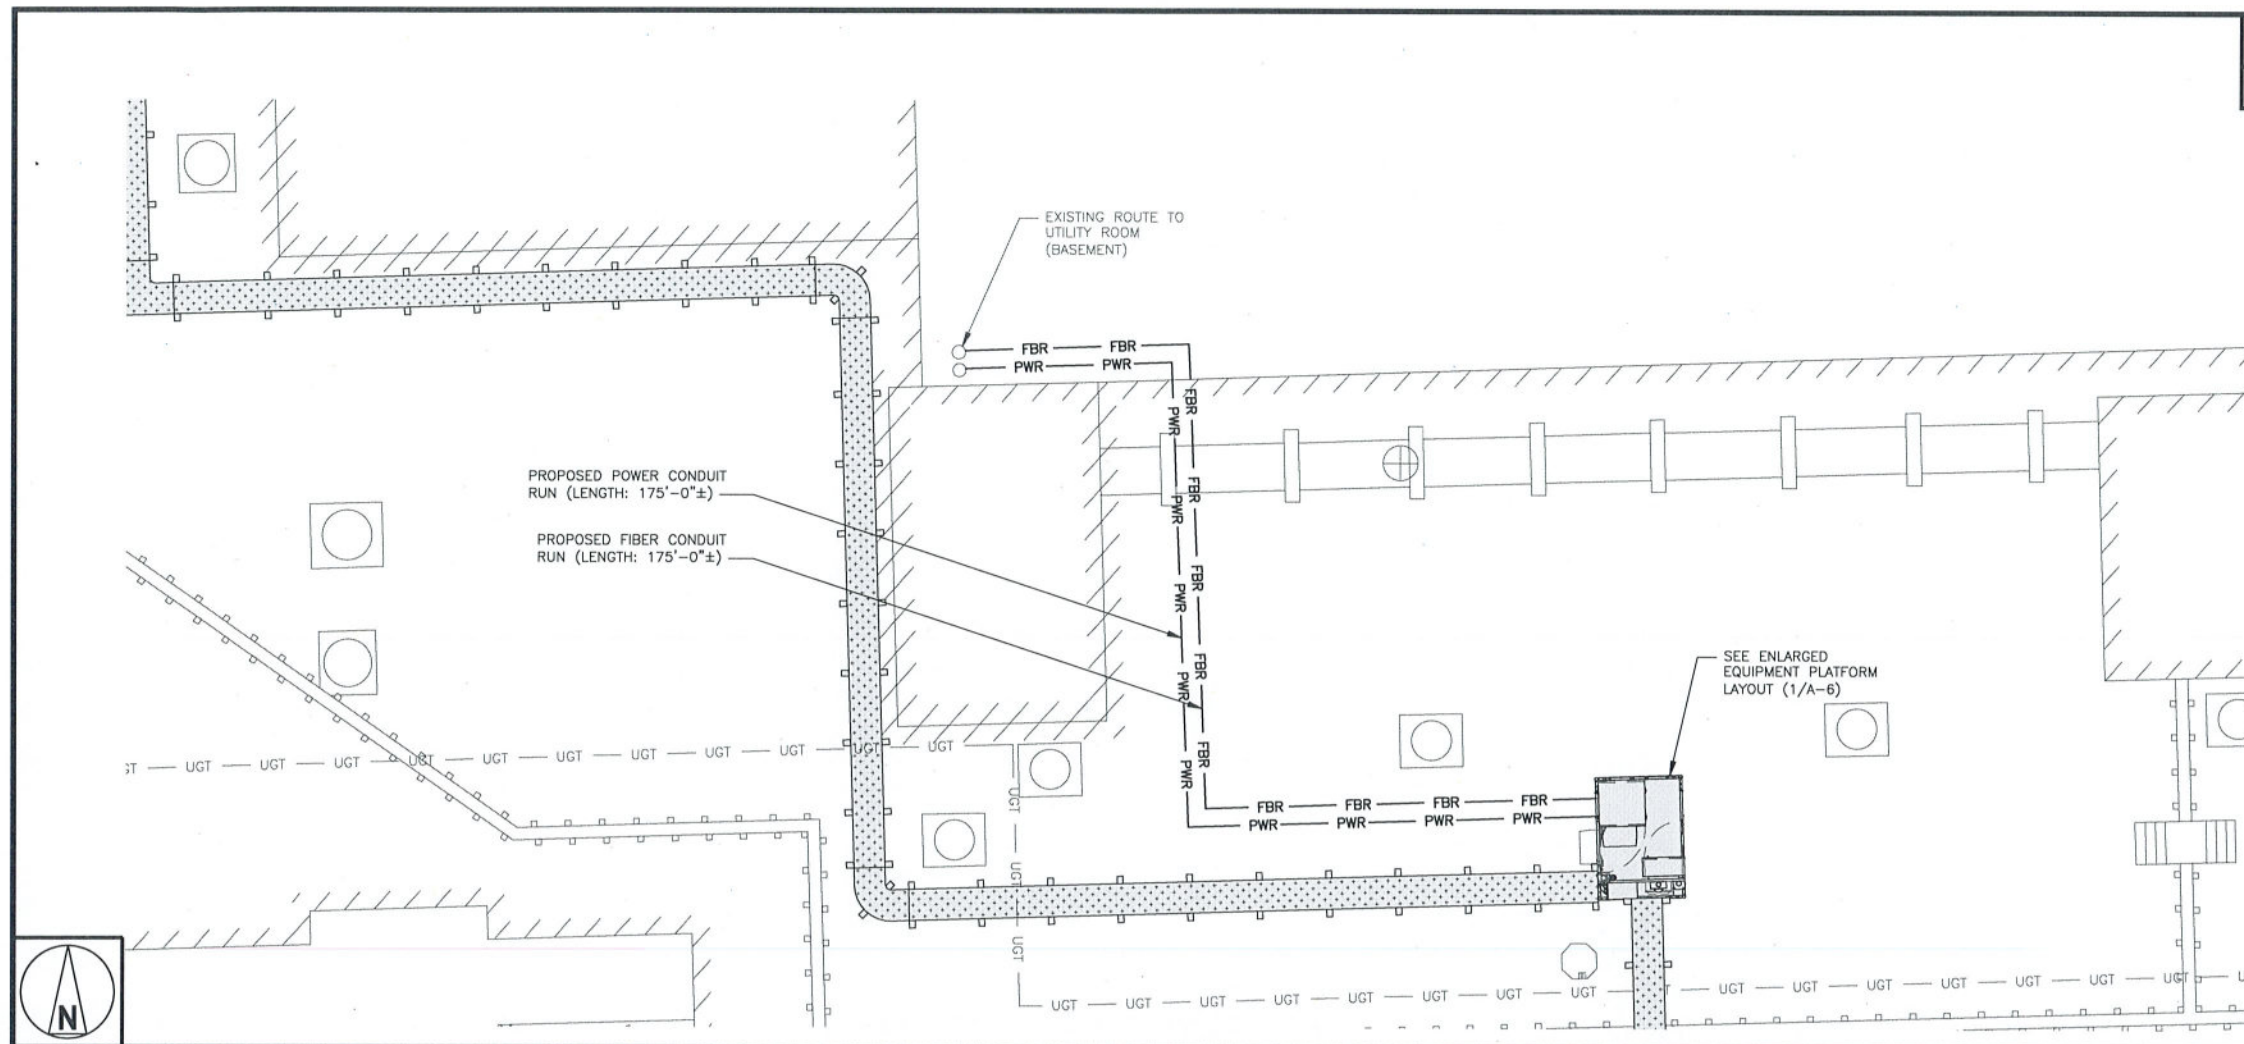
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SYRACUSE, NY 13205


SHEET TITLE
ELECTRICAL/FIBER ROUTE
PLAN AND NOTES

SHEET NUMBER

E-1



UTILITY ROUTE PLAN

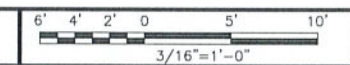


NOTES

- CONTRACTOR SHALL FIELD VERIFY ALL DIMENSIONS.
- E-MON D-MON MOUNTED IN THE UTILITY ROOM LOCATED IN THE **BASEMENT**. WILL NEED BUILDING MAINTENANCE FOR ROOM ACCESS.




UTILITY ROUTE ELEVATION

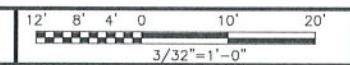

DC POWER WIRING SHALL BE COLOR CODED AT EACH END FOR IDENTIFYING +24V AND -48V CONDUCTORS. RED MARKINGS SHALL IDENTIFY +24V AND BLUE MARKINGS SHALL IDENTIFY -48V.

1. CONTRACTOR SHALL INSPECT THE EXISTING CONDITIONS PRIOR TO SUBMITTING A BID. ANY QUESTIONS ARISING DURING THE BID PERIOD IN REGARDS TO THE CONTRACTOR'S FUNCTIONS, THE SCOPE OF WORK, OR ANY OTHER ISSUE RELATED TO THIS PROJECT SHALL BE BROUGHT UP DURING THE BID PERIOD WITH THE PROJECT MANAGER FOR CLARIFICATION, NOT AFTER THE CONTRACT HAS BEEN AWARDED.
2. ALL ELECTRICAL WORK SHALL BE DONE IN ACCORDANCE WITH CURRENT NATIONAL ELECTRICAL CODES AND ALL STATE AND LOCAL CODES, LAWS, AND ORDINANCES. PROVIDE ALL COMPONENTS AND WIRING SIZES AS REQUIRED TO MEET NEC STANDARDS.
3. LOCATION OF EQUIPMENT, CONDUIT AND DEVICES SHOWN ON THE DRAWINGS ARE APPROXIMATE AND SHALL BE COORDINATED WITH FIELD CONDITIONS PRIOR TO CONSTRUCTION.
4. CONDUIT ROUGH-IN SHALL BE COORDINATED WITH THE MECHANICAL EQUIPMENT TO AVOID LOCATION CONFLICTS. VERIFY WITH THE MECHANICAL EQUIPMENT CONTRACTOR AND COMPLY AS REQUIRED.
5. CONTRACTOR SHALL PROVIDE ALL BREAKERS, CONDUITS AND CIRCUITS AS REQUIRED FOR A COMPLETE SYSTEM.
6. CONTRACTOR SHALL PROVIDE PULL BOXES AND JUNCTION BOXES AS REQUIRED BY THE NEC ARTICLE 314.
7. CONTRACTOR SHALL PROVIDE ALL STRAIN RELIEF AND CABLE SUPPORTS FOR ALL CABLE ASSEMBLIES. INSTALLATION SHALL BE IN ACCORDANCE WITH MANUFACTURER'S SPECIFICATIONS AND RECOMMENDATIONS.
8. ALL DISCONNECTS AND CONTROLLING DEVICES SHALL BE PROVIDED WITH ENGRAVED PHENOLIC NAMEPLATES INDICATING EQUIPMENT CONTROLLED, BRANCH CIRCUITS INSTALLED ON, AND PANEL FIELD LOCATIONS FED FROM.
9. INSTALL AN EQUIPMENT GROUNDING CONDUCTOR IN ALL CONDUITS PER THE SPECIFICATIONS AND NEC 250. THE EQUIPMENT GROUNDING CONDUCTORS SHALL BE BONDED AT ALL JUNCTION BOXES, PULL BOXES, AND ALL DISCONNECT SWITCHES, AND EQUIPMENT CABINETS.
10. ALL NEW MATERIAL SHALL HAVE A U.L. LABEL.
11. PANEL SCHEDULE LOADING AND CIRCUIT ARRANGEMENTS REFLECT POST-CONSTRUCTION EQUIPMENT.
12. CONTRACTOR SHALL BE RESPONSIBLE FOR AS-BUILT PANEL SCHEDULE AND SITE DRAWINGS.

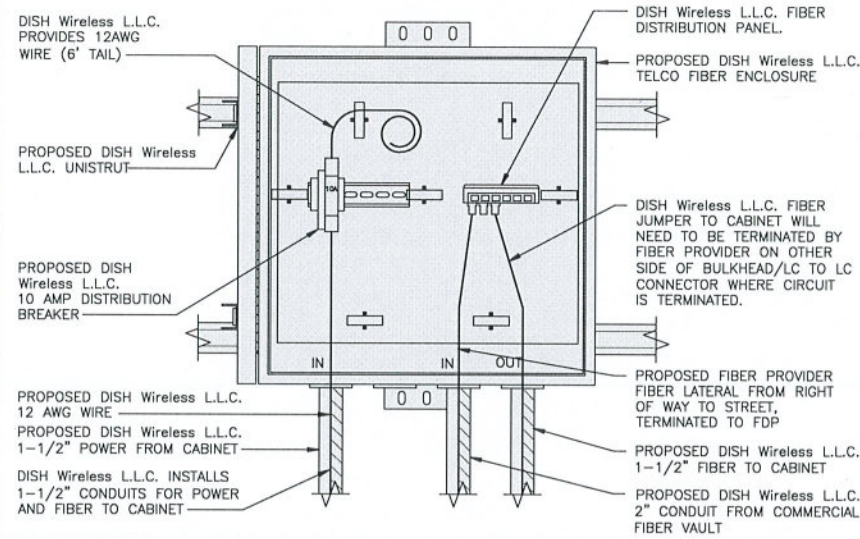

DARK TELCO BOX - INTERIOR WIRING LAYOUT

NO SCALE 2

NOT USED

NO SCALE 3

ELECTRICAL NOTES

NO SCALE 1

NOT USED

NO SCALE 4

NOT USED

NO SCALE 5

NOT USED

NO SCALE 6

NOT USED

NO SCALE 7

NOT USED

NO SCALE 8

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DISH Wireless L.L.C.
PROJECT INFORMATION
SYSYR00355B
122 W. SENECA TURNPIKE
SYRACUSE, NY 13205

SHEET TITLE
ELECTRICAL
DETAILS

SHEET NUMBER

E-2

CONSTRUCTION DOCUMENTS

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122 W. SENeca TURNPIKE
SYRACUSE, NY 13205

SHEET TITLE
GROUNDING PLANS
AND NOTES

SHEET NUMBER

G-1




GROUNDING LEGEND

- GROUNDING IS SHOWN DIAGRAMMATICALLY ONLY.
- CONTRACTOR SHALL GROUND ALL EQUIPMENT AS A COMPLETE SYSTEM. GROUNDING SHALL BE IN COMPLIANCE WITH NEC SECTION 250 AND DISH Wireless L.L.C. GROUNDING AND BONDING REQUIREMENTS AND MANUFACTURER'S SPECIFICATIONS.
- ALL GROUND CONDUCTORS SHALL BE COPPER; NO ALUMINUM CONDUCTORS SHALL BE USED.
- NO EXOTHERMIC WELDING ON ROOFTOP


GROUNDING ROOFTOP KEY NOTES

- EXTERIOR GROUND RING:** #2 AWG SOLID COPPER, BURIED AT A DEPTH OF AT LEAST 30 INCHES BELOW GRADE, OR 6 INCHES BELOW THE FROST LINE AND APPROXIMATELY 24 INCHES FROM THE EXTERIOR WALL OR FOOTING.
- ROOFTOP GROUND SYSTEM:** THE GROUND SYSTEM USING MINIMUM #2 AWG SOLID COPPER CONDUCTORS.
- INTERIOR GROUND RING:** #2 AWG STRANDED GREEN INSULATED COPPER CONDUCTOR EXTENDED AROUND THE PERIMETER OF THE EQUIPMENT AREA. ALL NON-TELECOMMUNICATIONS RELATED METALLIC OBJECTS FOUND WITHIN A SITE SHALL BE GROUNDED TO THE INTERIOR GROUND RING WITH #6 AWG STRANDED GREEN INSULATED CONDUCTOR.
- BOND TO INTERIOR GROUND RING:** #2 AWG SOLID TINNED COPPER WIRE PRIMARY BONDS SHALL BE PROVIDED AT LEAST AT FOUR POINTS ON THE INTERIOR GROUND RING, LOCATED AT THE CORNERS OF THE BUILDING OR ROOM.
- GROUND ROD:** UL LISTED COPPER CLAD STEEL. MINIMUM 1/2" DIAMETER BY EIGHT FEET LONG. GROUND RODS SHALL BE INSTALLED WITH INSPECTION SLEEVES. GROUND RODS SHALL BE DRIVEN TO THE DEPTH OF GROUND RING CONDUCTOR.
- CELL REFERENCE GROUND BAR (CRGB):** POINT OF GROUND REFERENCE FOR ALL COMMUNICATIONS EQUIPMENT FRAMES. ALL BONDS ARE MADE WITH #2 AWG UNLESS NOTED OTHERWISE STRANDED GREEN INSULATED COPPER CONDUCTORS. BOND TO COMMON BUILDING GROUND SYSTEM WITH (2) #2 SOLID TINNED COPPER CONDUCTORS.
- HATCH PLATE GROUND BAR:** BOND TO THE COMMON BUILDING GROUND SYSTEM WITH TWO #2 AWG STRANDED GREEN INSULATED COPPER CONDUCTORS. WHEN A HATCH-PLATE AND A CELL REFERENCE GROUND BAR ARE BOTH PRESENT, THE CRGB MUST BE CONNECTED TO THE HATCH-PLATE AND TO THE INTERIOR GROUND RING USING (2) TWO #2 AWG STRANDED GREEN INSULATED COPPER CONDUCTORS EACH.
- EXTERIOR CABLE ENTRY PORT GROUND BARS:** LOCATED AT THE ENTRANCE TO THE CELL SITE ROOM. BOND TO GROUND RING WITH A #2 AWG SOLID TINNED COPPER CONDUCTORS WITH MECHANICAL CONNECTIONS.
- TELCO GROUND BAR:** BOND TO BOTH CELL REFERENCE GROUND BAR OR EXTERIOR GROUND RING.
- FRAME BONDING:** THE BONDING POINT FOR TELECOM EQUIPMENT FRAMES SHALL BE THE GROUND BUS THAT IS NOT ISOLATED FROM THE EQUIPMENTS METAL FRAMEWORK.
- INTERIOR UNIT BONDS:** METAL FRAMES, CABINETS AND INDIVIDUAL METALLIC UNITS LOCATED WITH THE AREA OF THE INTERIOR GROUND RING REQUIRE A #6 AWG STRANDED GREEN INSULATED COPPER BOND TO THE INTERIOR GROUND RING.
- FENCE AND GATE GROUNDING:** METAL FENCES SHALL BE BONDED TO THE COMMON BUILDING GROUND SYSTEM WITH A #2 AWG SOLID TINNED COPPER CONDUCTOR AT AN INTERVAL NOT EXCEEDING 25 FEET. BONDS SHALL BE MADE AT EACH GATE POST AND ACROSS GATE OPENINGS.
- EXTERIOR UNIT BONDS:** METALLIC OBJECTS, EXTERNAL TO OR MOUNTED TO THE BUILDING, SHALL BE BONDED TO THE COMMON BUILDING GROUND SYSTEM. USING #2 TINNED SOLID COPPER WIRE
- ICE BRIDGE SUPPORTS:** EACH ICE BRIDGE LEG SHALL BE BONDED TO THE GROUND RING WITH #2 AWG BARE TINNED COPPER CONDUCTOR. PROVIDE EXOTHERMIC WELDS AT BOTH THE ICE BRIDGE LEG AND BURIED GROUND RING.
- DURING ALL DC POWER SYSTEM CHANGES INCLUDING DC SYSTEM CHANGE OUTFS, RECTIFIER REPLACEMENTS OR ADDITIONS, BREAKER DISTRIBUTION CHANGES, BATTERY ADDITIONS, BATTERY REPLACEMENTS AND INSTALLATIONS OR CHANGES TO DC CONVERTER SYSTEMS IT SHALL BE REQUIRED THAT SERVICE CONTRACTORS VERIFY ALL DC POWER SYSTEMS ARE EQUIPPED WITH A MASTER DC SYSTEM RETURN GROUND CONDUCTOR FROM THE DC POWER SYSTEM COMMON RETURN BUS DIRECTLY CONNECTED TO THE CELL SITE REFERENCE GROUND BAR**
- ROOFTOP COLLECTOR BUSS BAR IS TO BE MECHANICALLY BONDED TO COMMON BUILDING GROUND SYSTEM.**

REFER TO DISH Wireless L.L.C. GROUNDING NOTES.

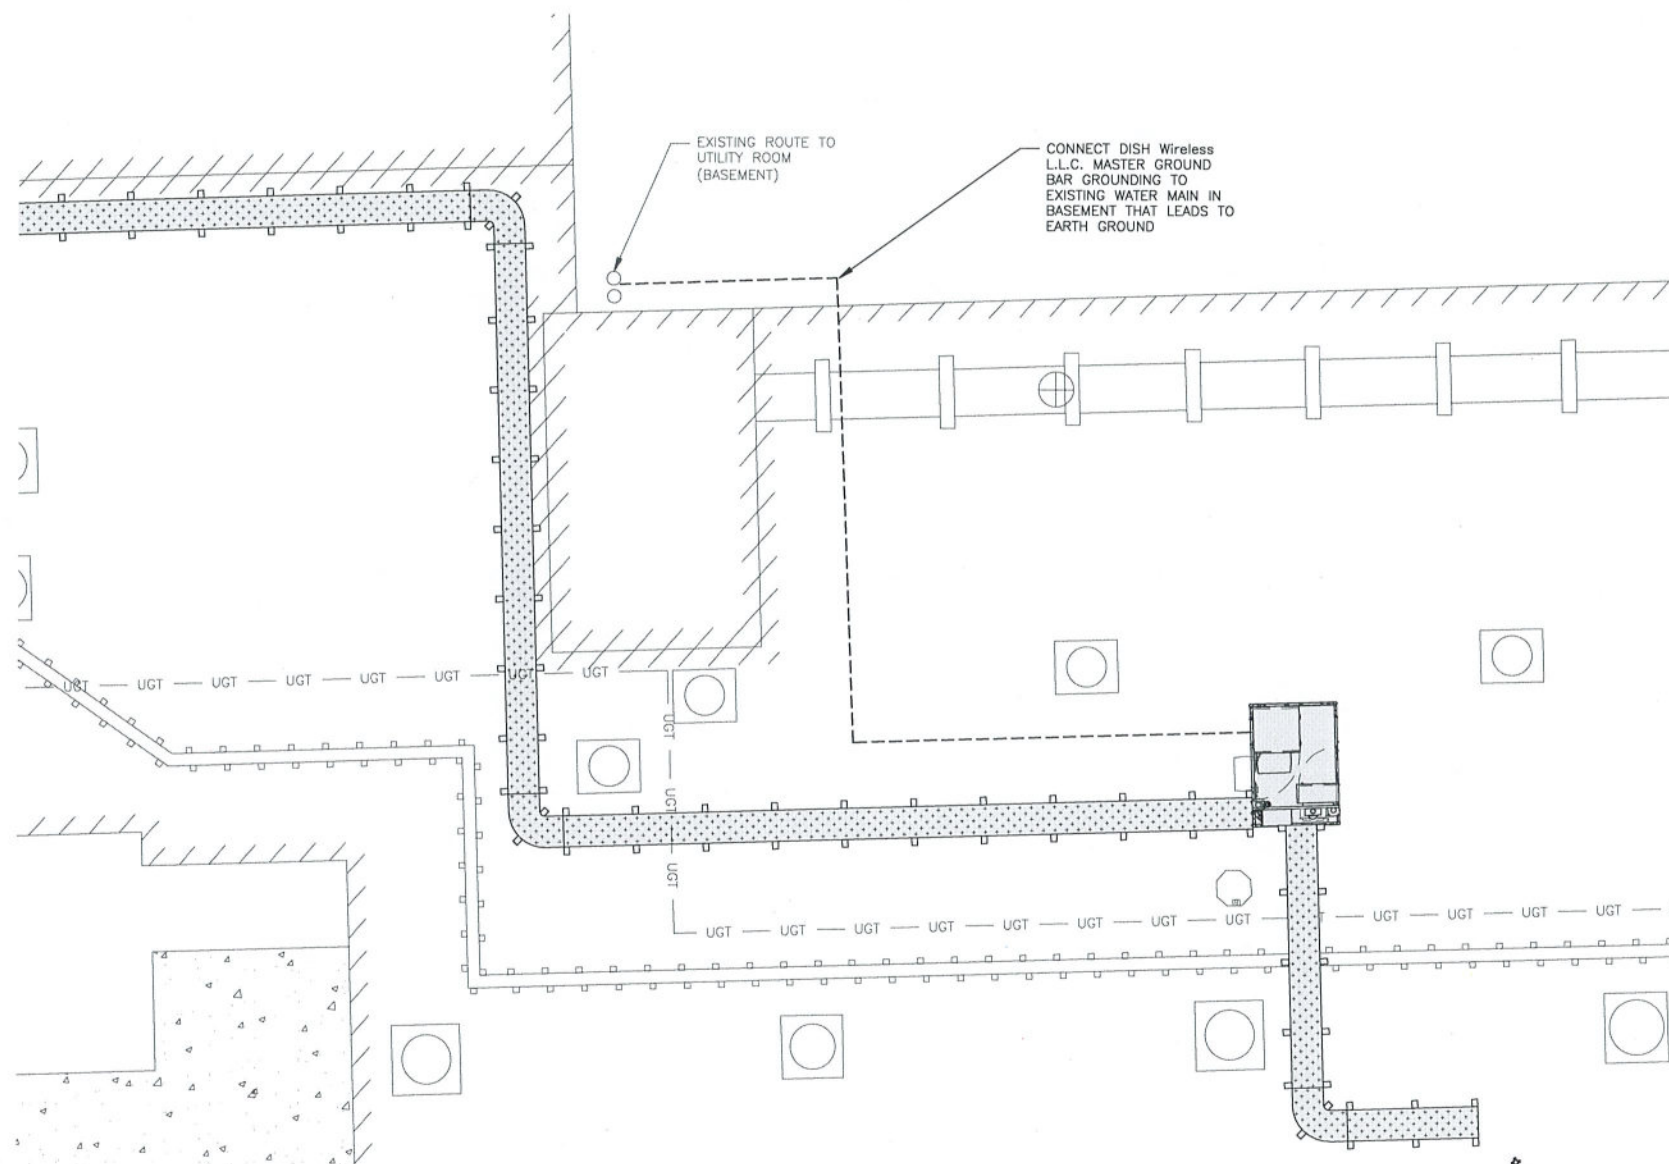

GROUNDING PLAN

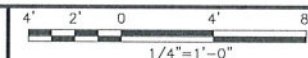


1

GROUNDING KEY NOTES


NO SCALE

2

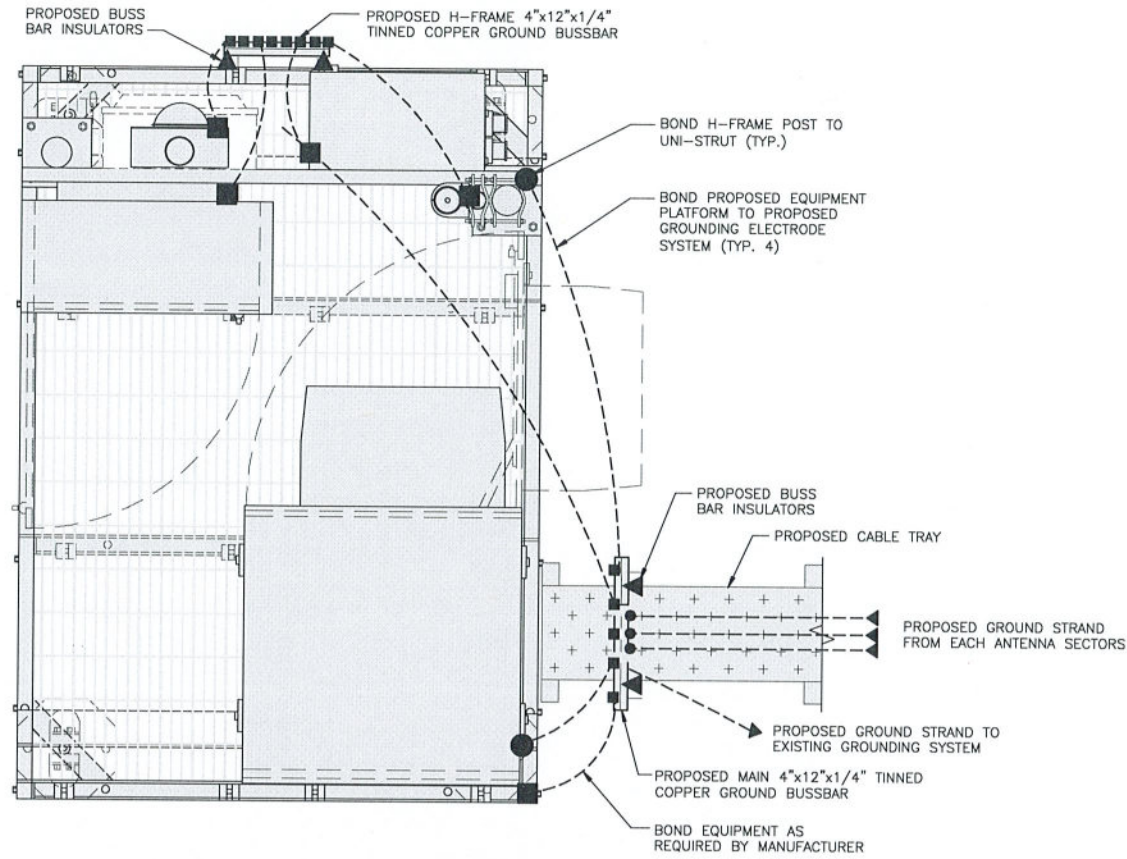

TYPICAL ROOFTOP EQUIPMENT GROUNDING PLAN


NO SCALE 1

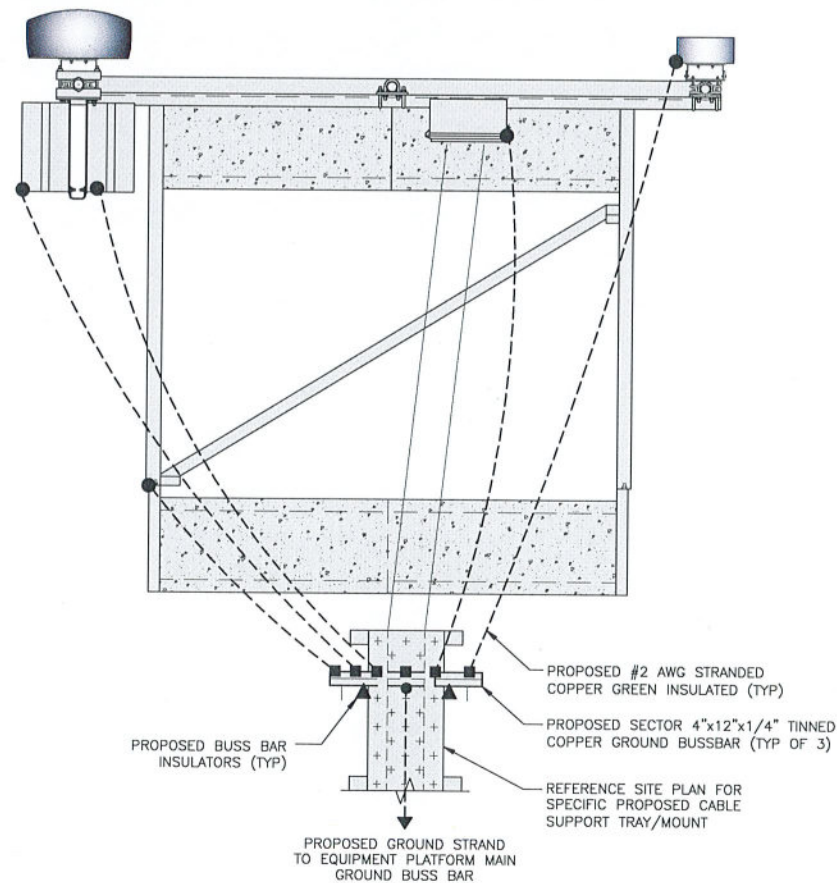

TYPICAL ROOFTOP ANTENNA GROUNDING PLAN

NO SCALE 2

NOTE
EQUIPMENT CABINET OMITTED FOR CLARITY

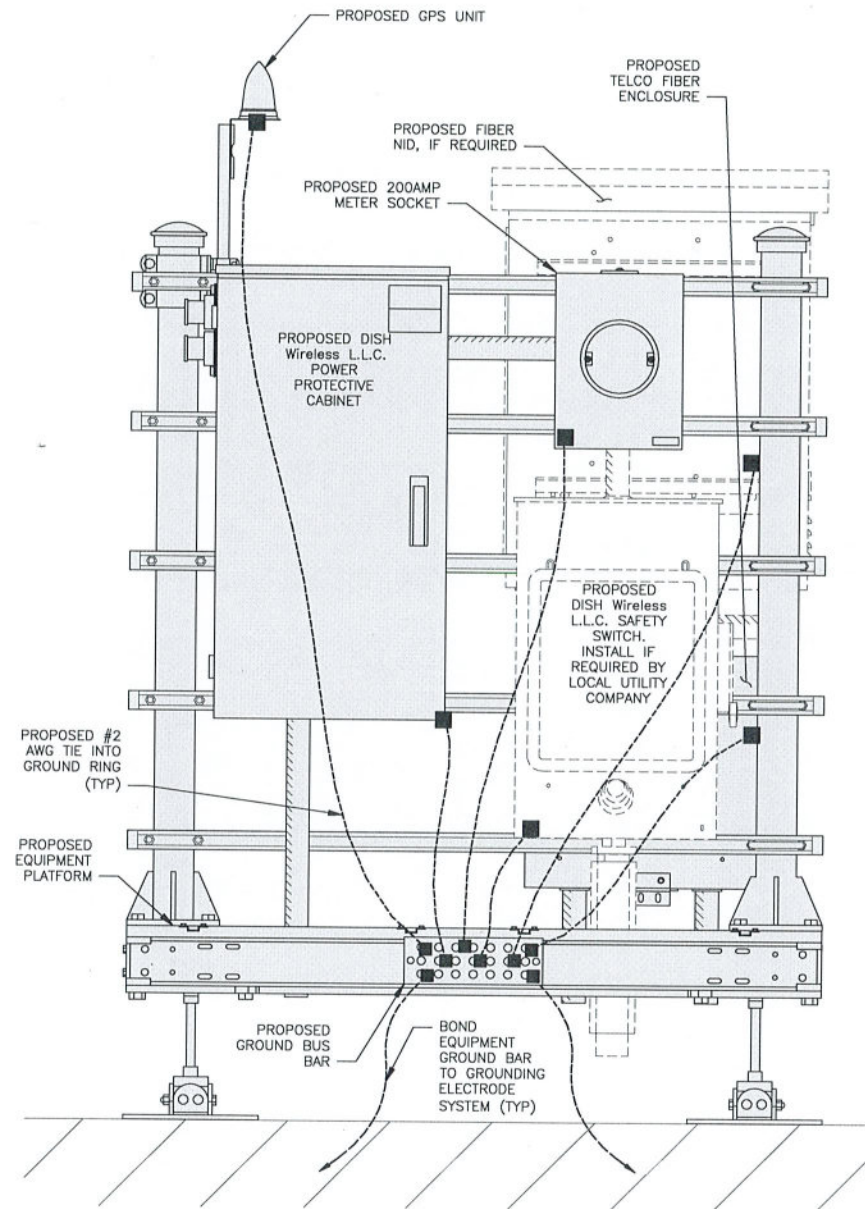

H-FRAME GROUNDING DETAIL

NO SCALE 3

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RFDS REV #: 0

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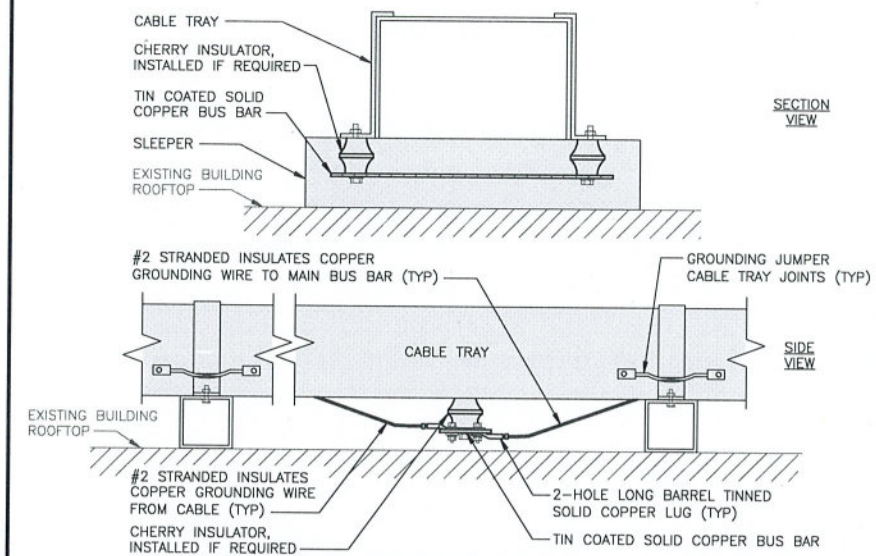
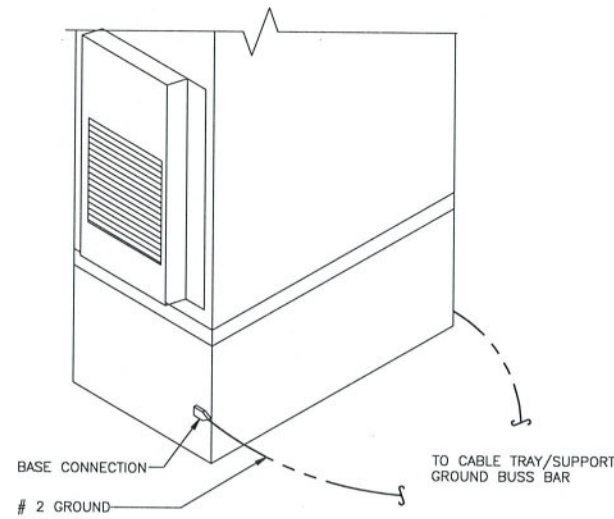
DISH Wireless L.L.C.
PROJECT INFORMATION
SYSR00355B
122 W. SENECA TURNPIKE
SYRACUSE, NY 13205

SHEET TITLE
GROUNDING DETAILS

SHEET NUMBER

G-2

1. EXOTHERMIC WELD (2) TWO, #2 AWG BARE TINNED SOLID COPPER CONDUCTORS TO GROUND BAR, ROUTE CONDUCTORS TO BURIED GROUND RING AND PROVIDE PARALLEL EXOTHERMIC WELD.
2. ALL EXTERIOR GROUNDING HARDWARE SHALL BE STAINLESS STEEL 3/8" DIAMETER OR LARGER. ALL HARDWARE 18-8 STAINLESS STEEL INCLUDING LOCK WASHERS, COAT ALL SURFACES WITH AN ANTI-OXIDANT COMPOUND BEFORE MATING.
3. FOR GROUND BOND TO STEEL ONLY: COAT ALL SURFACES WITH AN ANTI-OXIDANT COMPOUND BEFORE MATING.
4. DO NOT INSTALL CABLE GROUNDING KIT AT A BEND AND ALWAYS DIRECT GROUND CONDUCTOR DOWN TO GROUNDING BUS.
5. NUT & WASHER SHALL BE PLACED ON THE FRONT SIDE OF THE GROUND BAR AND BOLTED ON THE BACK SIDE.
6. ALL GROUNDING PARTS AND EQUIPMENT TO BE SUPPLIED AND INSTALLED BY CONTRACTOR.
7. THE CONTRACTOR SHALL BE RESPONSIBLE FOR INSTALLING ADDITIONAL GROUND BAR AS REQUIRED.
8. ENSURE THE WIRE INSULATION TERMINATION IS WITHIN 1/8" OF THE BARREL (NO SHINERS).



TYPICAL GROUNDING NOTES

NO SCALE

1

OUTDOOR CABINET GROUNDING


NO SCALE

2

TYPICAL CABLE TRAY GROUND BUSS BAR

NO SCALE


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LUG DETAIL

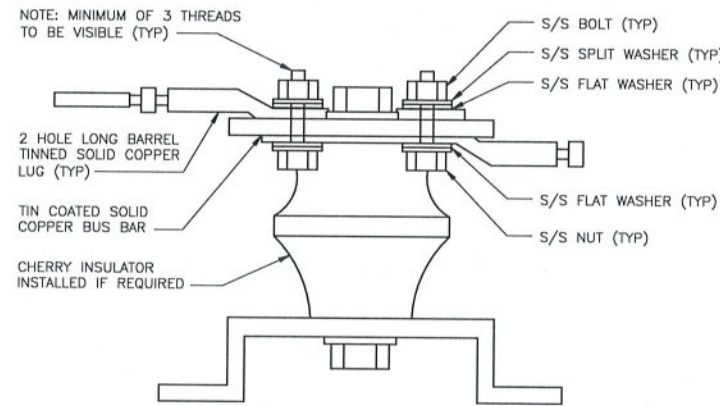NO SCALE


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TYPICAL EXTERIOR TWO HOLE LUG

NO SCALE


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TYPICAL INTERIOR TWO HOLE LUG

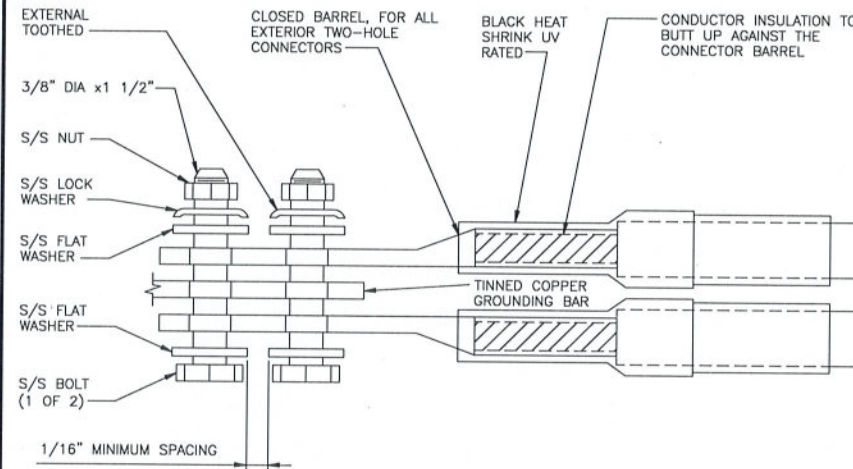NO SCALE


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TYPICAL INDOOR ELECTRICAL ENCLOSURE BOX GROUNDING DETAIL

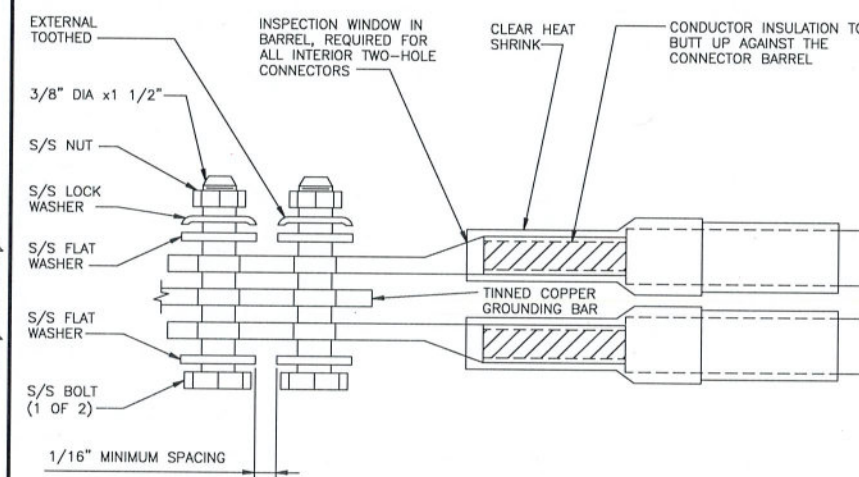NO SCALE

7

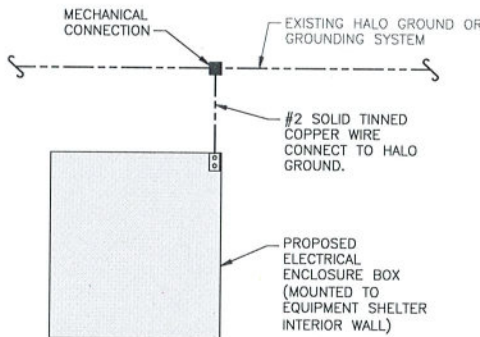


TYPICAL GPS UNIT GROUNDING

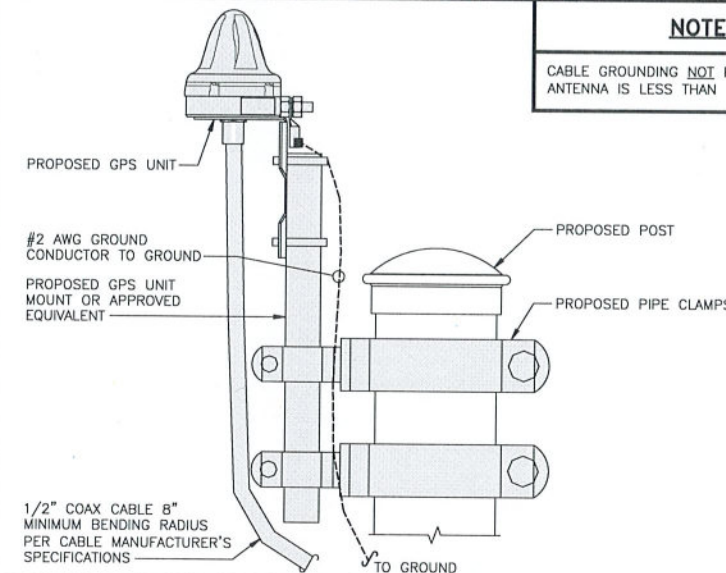NO SCALE

8

NOTES
CABLE GROUNDING NOT REQUIRED WHEN ANTENNA IS LESS THAN 10' FROM CABINET

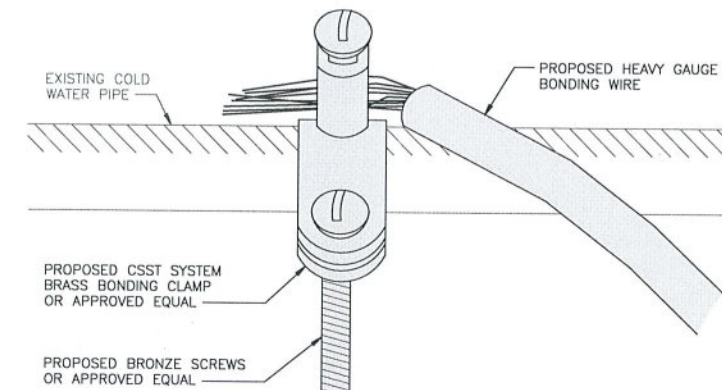

TYPICAL COLD WATER CONDUIT GROUNDING DETAIL

NO SCALE

9

NOTE
REMOVE ANY PAINT ON PIPE OR FITTING SURFACE UNDER BONDING CLAMP.



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SYRACUSE, NY 13205

SHEET TITLE
GROUNDING DETAILS

SHEET NUMBER

G-3

RF JUMPER COLOR CODING

3/4" TAPE WIDTHS WITH 3/4" SPACING

LOW-BAND RRH -
(600MHz N71 BASEBAND) +
(850MHz N26 BAND) +
(700MHz N29 BAND) - OPTIONAL PER MARKET

ADD FREQUENCY COLOR TO SECTOR BAND
(CBRS WILL USE YELLOW BANDS)

ALPHA RRH				BETA RRH				GAMMA RRH			
PORT 1 + SLANT	PORT 2 - SLANT	PORT 3 + SLANT	PORT 4 - SLANT	PORT 1 + SLANT	PORT 2 - SLANT	PORT 3 + SLANT	PORT 4 - SLANT	PORT 1 + SLANT	PORT 2 - SLANT	PORT 3 + SLANT	PORT 4 - SLANT
RED	RED	RED	RED	BLUE	BLUE	BLUE	BLUE	GREEN	GREEN	GREEN	GREEN
ORANGE	ORANGE	RED	RED	ORANGE	ORANGE	BLUE	BLUE	ORANGE	ORANGE	GREEN	GREEN
	WHITE (-) PORT	ORANGE	ORANGE		WHITE (-) PORT	ORANGE	ORANGE		WHITE (-) PORT	ORANGE	ORANGE
			WHITE (-) PORT				WHITE (-) PORT				WHITE (-) PORT

MID-BAND RRH -
(AWS BANDS N66+N70)

ADD FREQUENCY COLOR TO SECTOR BAND
(CBRS WILL USE YELLOW BANDS)

RED	RED	RED	RED	BLUE	BLUE	BLUE	BLUE	GREEN	GREEN	GREEN	GREEN
PURPLE	PURPLE	RED	RED	PURPLE	PURPLE	BLUE	BLUE	PURPLE	PURPLE	GREEN	GREEN
	WHITE (-) PORT	PURPLE	PURPLE		WHITE (-) PORT	PURPLE	PURPLE		WHITE (-) PORT	PURPLE	PURPLE
			WHITE (-) PORT				WHITE (-) PORT				WHITE (-) PORT

HYBRID/DISCREET CABLES

INCLUDE SECTOR BANDS BEING SUPPORTED
ALONG WITH FREQUENCY BANDS

EXAMPLE 1 - HYBRID, OR DISCREET, SUPPORTS
ALL SECTORS, BOTH LOW-BANDS AND MID-BANDS

EXAMPLE 2 - HYBRID, OR DISCREET, SUPPORTS
CBRS ONLY, ALL SECTORS

EXAMPLE 1	EXAMPLE 2	EXAMPLE 3
RED	RED	RED
BLUE	BLUE	
GREEN	GREEN	ORANGE
ORANGE	YELLOW	PURPLE
PURPLE		

FIBER JUMPERS TO RRHs

LOW-BAND RRH FIBER CABLES HAVE SECTOR
STRIPE ONLY

LOW BAND RRH	HIGH BAND RRH	LOW BAND RRH	HIGH BAND RRH	LOW BAND RRH	HIGH BAND RRH
RED	RED	BLUE	BLUE	GREEN	GREEN
	PURPLE		PURPLE		PURPLE

POWER CABLES TO RRHs

LOW-BAND RRH POWER CABLES HAVE SECTOR
STRIPE ONLY

LOW BAND RRH	HIGH BAND RRH	LOW BAND RRH	HIGH BAND RRH	LOW BAND RRH	HIGH BAND RRH
RED	RED	BLUE	BLUE	GREEN	GREEN
	PURPLE		PURPLE		PURPLE

RET MOTORS AT ANTENNAS

ANTENNA 1 LOW BAND/ "IN"	ANTENNA 1 HIGH BAND/ "IN"	ANTENNA 1 LOW BAND/ "IN"	ANTENNA 1 HIGH BAND/ "IN"	ANTENNA 1 LOW BAND/ "IN"	ANTENNA 1 HIGH BAND/ "IN"
RED	RED	BLUE	BLUE	GREEN	GREEN
	PURPLE		PURPLE		PURPLE

MICROWAVE RADIO LINKS

LINKS WILL HAVE A 1.5-2 INCH WHITE WRAP WITH
THE AZIMUTH COLOR OVERLAPPING IN THE MIDDLE.
ADD ADDITIONAL SECTOR COLOR BANDS FOR EACH
ADDITIONAL MW RADIO.

MICROWAVE CABLES WILL REQUIRE P-TOUCH
LABELS INSIDE THE CABINET TO IDENTIFY THE
LOCAL AND REMOTE SITE ID'S

FORWARD AZIMUTH OF 0-120 DEGREES		FORWARD AZIMUTH OF 120-240 DEGREES		FORWARD AZIMUTH OF 240-360 DEGREES	
PRIMARY	SECONDARY	PRIMARY	SECONDARY	PRIMARY	SECONDARY
WHITE	WHITE	WHITE	WHITE	WHITE	WHITE
RED	RED	BLUE	BLUE	GREEN	GREEN
WHITE	WHITE	WHITE	WHITE	WHITE	WHITE
	RED	BLUE	BLUE	GREEN	GREEN
	WHITE	WHITE	WHITE	WHITE	WHITE

RF CABLE COLOR CODES

NO SCALE

1

NOT USED


NO SCALE

4

LOW BANDS (N71+N26)
OPTIONAL - (N29)




AWS
(N66+N70+H-BLOCK)

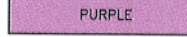

CBRS TECH
(3 GHz)



NEGATIVE SLANT PORT
ON ANT/RRH

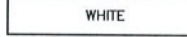


ALPHA SECTOR



BETA SECTOR



GAMMA SECTOR

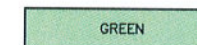

COLOR IDENTIFIER

NO SCALE

2

NOT USED

NO SCALE

3

NOT USED

NO SCALE

4

dish
wireless.

5701 SOUTH SANTA FE DRIVE
LITTLETON, CO 80120

TILSON
On a Mission

16 MIDDLE STREET, 4TH FLOOR
PORTLAND, ME 04101

Alec Scott Norris
NEW YORK LICENSED PROFESSIONAL ENGINEER
LICENSE NUMBER: 096835-1
COLLIERS ENGINEERING & DESIGN CT, P.C.
N.Y. C.O.A.#. 0017609

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AF DR MPC

RFDS REV #: 0

CONSTRUCTION DOCUMENTS

SUBMITTALS

REV	DATE	DESCRIPTION
A	07/15/2021	ISSUED FOR REVIEW
0	08/11/2021	ISSUED FOR CONSTRUCTION

A&E PROJECT NUMBER

20933018A

DISH Wireless L.L.C.
PROJECT INFORMATION

SYSR00355B
122 W. SENECA TURNPIKE
SYRACUSE, NY 13205


SHEET TITLE

RF
CABLE COLOR CODE

SHEET NUMBER

RF-1

EXOTHERMIC CONNECTION
 MECHANICAL CONNECTION
 BUSS BAR INSULATOR
 CHEMICAL ELECTROLYTIC GROUNDING SYSTEM
 TEST CHEMICAL ELECTROLYTIC GROUNDING SYSTEM
 EXOTHERMIC WITH INSPECTION SLEEVE
 GROUNDING BAR
 GROUND ROD
 TEST GROUND ROD WITH INSPECTION SLEEVE
 SINGLE POLE SWITCH
 DUPLEX RECEPTACLE
 DUPLEX GFCI RECEPTACLE
 FLUORESCENT LIGHTING FIXTURE (2) TWO LAMPS 48-T8
 SMOKE DETECTION (DC)
 EMERGENCY LIGHTING (DC)
 SECURITY LIGHT W/PHOTOCELL LITHONIA ALXW
 LED-1-25A400/51K-SR4-120-PE-DBBTXD
 CHAIN LINK FENCE
 WOOD/WROUGHT IRON FENCE
 WALL STRUCTURE
 LEASE AREA
 PROPERTY LINE (PL)
 SETBACKS
 ICE BRIDGE
 CABLE TRAY
 WATER LINE
 UNDERGROUND POWER
 UNDERGROUND TELCO
 OVERHEAD POWER
 OVERHEAD TELCO
 UNDERGROUND TELCO/POWER
 ABOVE GROUND POWER
 ABOVE GROUND TELCO
 ABOVE GROUND TELCO/POWER
 WORKPOINT

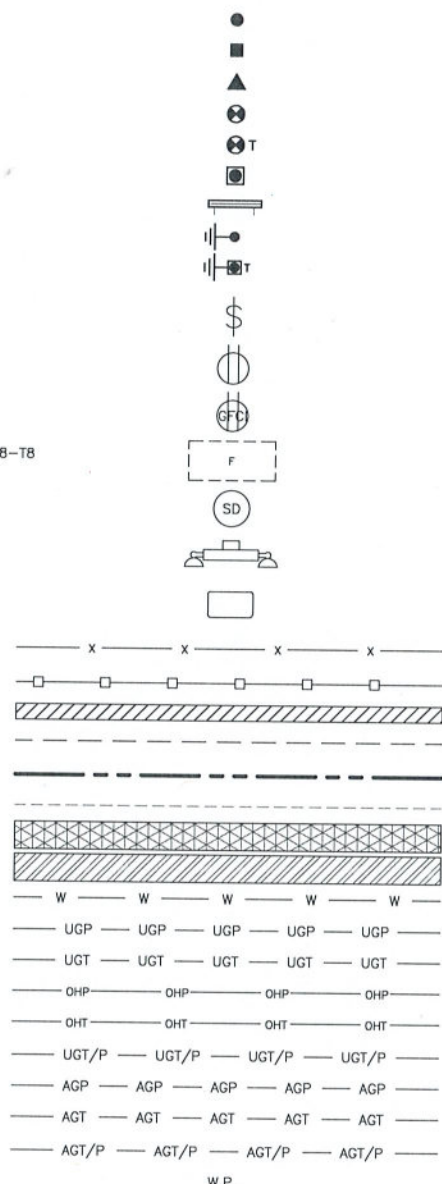

SECTION REFERENCE



DETAIL REFERENCE



LEGEND

AB ANCHOR BOLT	IN INCH
ABV ABOVE	INT INTERIOR
AC ALTERNATING CURRENT	LB(S) POUND(S)
ADDL ADDITIONAL	LF LINEAR FEET
AFF ABOVE FINISHED FLOOR	LTE LONG TERM EVOLUTION
AFG ABOVE FINISHED GRADE	MAS MASONRY
AGL ABOVE GROUND LEVEL	MAX MAXIMUM
AIC AMPERAGE INTERRUPTION CAPACITY	MB MACHINE BOLT
ALUM ALUMINUM	MECH MECHANICAL
ALT ALTERNATE	MFR MANUFACTURER
ANT ANTENNA	MGB MASTER GROUND BAR
APPROX APPROXIMATE	MIN MINIMUM
ARCH ARCHITECTURAL	MISC MISCELLANEOUS
ATS AUTOMATIC TRANSFER SWITCH	MTL METAL
AWG AMERICAN WIRE GAUGE	MTS MANUAL TRANSFER SWITCH
BATT BATTERY	MW MICROWAVE
BLDG BUILDING	NEC NATIONAL ELECTRIC CODE
BLK BLOCK	NM NEWTON METERS
BLKG BLOCKING	NO. NUMBER
BM BEAM	# NUMBER
BTC BARE TINNED COPPER CONDUCTOR	NTS NOT TO SCALE
BOF BOTTOM OF FOOTING	OC ON-CENTER
CAB CABINET	OSHA OCCUPATIONAL SAFETY AND HEALTH ADMINISTRATION
CANT CANTILEVERED	OPNG OPENING
CHG CHARGING	P/C PRECAST CONCRETE
CLG CEILING	PCS PERSONAL COMMUNICATION SERVICES
CLR CLEAR	PCU PRIMARY CONTROL UNIT
COL COLUMN	PRC PRIMARY RADIO CABINET
COMM COMMON	PP POLARIZING PRESERVING
CONC CONCRETE	PSF POUNDS PER SQUARE FOOT
CONSTR CONSTRUCTION	PSI POUNDS PER SQUARE INCH
DBL DOUBLE	PT PRESSURE TREATED
DC DIRECT CURRENT	PWR POWER CABINET
DEPT DEPARTMENT	QTY QUANTITY
DF DOUGLAS FIR	RAD RADIUS
DIA DIAMETER	RECT RECTIFIER
DIAG DIAGONAL	REF REFERENCE
DIM DIMENSION	REINF REINFORCEMENT
DWG DRAWING	REQ'D REQUIRED
DWL DOWEL	RET REMOTE ELECTRIC TILT
EA EACH	RF RADIO FREQUENCY
EC ELECTRICAL CONDUCTOR	RMC RIGID METALLIC CONDUIT
EL. ELEVATION	RRH REMOTE RADIO HEAD
ELEC ELECTRICAL	RRU REMOTE RADIO UNIT
EMT ELECTRICAL METALLIC TUBING	RWY RACEWAY
ENG ENGINEER	SCH SCHEDULE
EQ EQUAL	SHT SHEET
EXP EXPANSION	SIAD SMART INTEGRATED ACCESS DEVICE
EXT EXTERIOR	SIM SIMILAR
EW EACH WAY	SPEC SPECIFICATION
FAB FABRICATION	SQ SQUARE
FF FINISH FLOOR	SS STAINLESS STEEL
FG FINISH GRADE	STD STANDARD
FIF FACILITY INTERFACE FRAME	STL STEEL
FIN FINISH(ED)	TEMP TEMPORARY
FLR FLOOR	THK THICKNESS
FDN FOUNDATION	TMA TOWER MOUNTED AMPLIFIER
FOC FACE OF CONCRETE	TN TOE NAIL
FOM FACE OF MASONRY	TOA TOP OF ANTENNA
FOS FACE OF STUD	TOC TOP OF CURB
FOW FACE OF WALL	TOF TOP OF FOUNDATION
FS FINISH SURFACE	TOP TOP OF PLATE (PARAPET)
FT FOOT	TOS TOP OF STEEL
FTG FOOTING	TOW TOP OF WALL
GA GAUGE	TVSS TRANSIENT VOLTAGE SURGE SUPPRESSION
GEN GENERATOR	TYP TYPICAL
GFCI GROUND FAULT CIRCUIT INTERRUPTER	UG UNDERGROUND
GLB GLUE LAMINATED BEAM	UL UNDERWRITERS LABORATORY
GLV GALVANIZED	UNO UNLESS NOTED OTHERWISE
GPS GLOBAL POSITIONING SYSTEM	UMTS UNIVERSAL MOBILE TELECOMMUNICATIONS SYSTEM
GND GROUND	UPS UNINTERRUPTIBLE POWER SYSTEM (DC POWER PLANT)
GSM GLOBAL SYSTEM FOR MOBILE	VIF VERIFIED IN FIELD
HDG HOT DIPPED GALVANIZED	W WIDE
HDR HEADER	W/ WITH
HGR HANGER	WD WOOD
HVAC HEAT/VENTILATION/AIR CONDITIONING	WP WEATHERPROOF
HT HEIGHT	WT WEIGHT
IGR INTERIOR GROUND RING	

ABBREVIATIONS



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DISH Wireless L.L.C.
 PROJECT INFORMATION
 SYSYR00355B
 122 W. SENECA TURNPIKE
 SYRACUSE, NY 13205

SHEET TITLE
 LEGEND AND ABBREVIATIONS

SHEET NUMBER
GN-1

SITE ACTIVITY REQUIREMENTS:

1. NOTICE TO PROCEED – NO WORK SHALL COMMENCE PRIOR TO CONTRACTOR RECEIVING A WRITTEN NOTICE TO PROCEED (NTP) AND THE ISSUANCE OF A PURCHASE ORDER. PRIOR TO ACCESSING/ENTERING THE SITE YOU MUST CONTACT THE DISH Wireless L.L.C. AND TOWER OWNER NOC & THE DISH Wireless L.L.C. AND TOWER OWNER CONSTRUCTION MANAGER.
2. "LOOK UP" – DISH Wireless L.L.C. AND TOWER OWNER SAFETY CLIMB REQUIREMENT:
THE INTEGRITY OF THE SAFETY CLIMB AND ALL COMPONENTS OF THE CLIMBING FACILITY SHALL BE CONSIDERED DURING ALL STAGES OF DESIGN, INSTALLATION, AND INSPECTION. TOWER MODIFICATION, MOUNT REINFORCEMENTS, AND/OR EQUIPMENT INSTALLATIONS SHALL NOT COMPROMISE THE INTEGRITY OR FUNCTIONAL USE OF THE SAFETY CLIMB OR ANY COMPONENTS OF THE CLIMBING FACILITY ON THE STRUCTURE. THIS SHALL INCLUDE, BUT NOT BE LIMITED TO: PINCHING OF THE WIRE ROPE, BENDING OF THE WIRE ROPE FROM ITS SUPPORTS, DIRECT CONTACT OR CLOSE PROXIMITY TO THE WIRE ROPE WHICH MAY CAUSE FRICTIONAL WEAR, IMPACT TO THE ANCHORAGE POINTS IN ANY WAY, OR TO IMPEDE/BLOCK ITS INTENDED USE. ANY COMPROMISED SAFETY CLIMB, INCLUDING EXISTING CONDITIONS MUST BE TAGGED OUT AND REPORTED TO YOUR DISH Wireless L.L.C. AND DISH Wireless L.L.C. AND TOWER OWNER POC OR CALL THE NOC TO GENERATE A SAFETY CLIMB MAINTENANCE AND CONTRACTOR NOTICE TICKET.
3. PRIOR TO THE START OF CONSTRUCTION, ALL REQUIRED JURISDICTIONAL PERMITS SHALL BE OBTAINED. THIS INCLUDES, BUT IS NOT LIMITED TO, BUILDING, ELECTRICAL, MECHANICAL, FIRE, FLOOD ZONE, ENVIRONMENTAL, AND ZONING. AFTER ONSITE ACTIVITIES AND CONSTRUCTION ARE COMPLETED, ALL REQUIRED PERMITS SHALL BE SATISFIED AND CLOSED OUT ACCORDING TO LOCAL JURISDICTIONAL REQUIREMENTS.
4. ALL CONSTRUCTION MEANS AND METHODS; INCLUDING BUT NOT LIMITED TO, ERECTION PLANS, RIGGING PLANS, CLIMBING PLANS, AND RESCUE PLANS SHALL BE THE RESPONSIBILITY OF THE GENERAL CONTRACTOR RESPONSIBLE FOR THE EXECUTION OF THE WORK CONTAINED HEREIN, AND SHALL MEET ANSI/ASSE A10.48 (LATEST EDITION); FEDERAL, STATE, AND LOCAL REGULATIONS; AND ANY APPLICABLE INDUSTRY CONSENSUS STANDARDS RELATED TO THE CONSTRUCTION ACTIVITIES BEING PERFORMED. ALL RIGGING PLANS SHALL ADHERE TO ANSI/ASSE A10.48 (LATEST EDITION) AND DISH Wireless L.L.C. AND TOWER OWNER STANDARDS, INCLUDING THE REQUIRED INVOLVEMENT OF A QUALIFIED ENGINEER FOR CLASS IV CONSTRUCTION, TO CERTIFY THE SUPPORTING STRUCTURE(S) IN ACCORDANCE WITH ANSI/TIA-322 (LATEST EDITION).
5. ALL SITE WORK TO COMPLY WITH DISH Wireless L.L.C. AND TOWER OWNER INSTALLATION STANDARDS FOR CONSTRUCTION ACTIVITIES ON DISH Wireless L.L.C. AND TOWER OWNER TOWER SITE AND LATEST VERSION OF ANSI/TIA-1019-A-2012 "STANDARD FOR INSTALLATION, ALTERATION, AND MAINTENANCE OF ANTENNA SUPPORTING STRUCTURES AND ANTENNAS."
6. IF THE SPECIFIED EQUIPMENT CAN NOT BE INSTALLED AS SHOWN ON THESE DRAWINGS, THE CONTRACTOR SHALL PROPOSE AN ALTERNATIVE INSTALLATION FOR APPROVAL BY DISH Wireless L.L.C. AND TOWER OWNER PRIOR TO PROCEEDING WITH ANY SUCH CHANGE OF INSTALLATION.
7. ALL MATERIALS FURNISHED AND INSTALLED SHALL BE IN STRICT ACCORDANCE WITH ALL APPLICABLE CODES, REGULATIONS AND ORDINANCES. CONTRACTOR SHALL ISSUE ALL APPROPRIATE NOTICES AND COMPLY WITH ALL LAWS, ORDINANCES, RULES, REGULATIONS AND LAWFUL ORDERS OF ANY PUBLIC AUTHORITY REGARDING THE PERFORMANCE OF THE WORK. ALL WORK CARRIED OUT SHALL COMPLY WITH ALL APPLICABLE MUNICIPAL AND UTILITY COMPANY SPECIFICATIONS AND LOCAL JURISDICTIONAL CODES, ORDINANCES AND APPLICABLE REGULATIONS.
8. THE CONTRACTOR SHALL INSTALL ALL EQUIPMENT AND MATERIALS IN ACCORDANCE WITH MANUFACTURER'S RECOMMENDATIONS UNLESS SPECIFICALLY STATED OTHERWISE.
9. THE CONTRACTOR SHALL CONTACT UTILITY LOCATING SERVICES INCLUDING PRIVATE LOCATES SERVICES PRIOR TO THE START OF CONSTRUCTION.
10. ALL EXISTING ACTIVE SEWER, WATER, GAS, ELECTRIC AND OTHER UTILITIES WHERE ENCOUNTERED IN THE WORK, SHALL BE PROTECTED AT ALL TIMES AND WHERE REQUIRED FOR THE PROPER EXECUTION OF THE WORK, SHALL BE RELOCATED AS DIRECTED BY CONTRACTOR. EXTREME CAUTION SHOULD BE USED BY THE CONTRACTOR WHEN EXCAVATING OR DRILLING PIERS AROUND OR NEAR UTILITIES. CONTRACTOR SHALL PROVIDE SAFETY TRAINING FOR THE WORKING CREW. THIS WILL INCLUDE BUT NOT BE LIMITED TO A) FALL PROTECTION B) CONFINED SPACE C) ELECTRICAL SAFETY D) TRENCHING AND EXCAVATION E) CONSTRUCTION SAFETY PROCEDURES.
11. ALL SITE WORK SHALL BE AS INDICATED ON THE STAMPED CONSTRUCTION DRAWINGS AND DISH PROJECT SPECIFICATIONS, LATEST APPROVED REVISION.
12. CONTRACTOR SHALL KEEP THE SITE FREE FROM ACCUMULATING WASTE MATERIAL, DEBRIS, AND TRASH AT THE COMPLETION OF THE WORK. IF NECESSARY, RUBBISH, STUMPS, DEBRIS, STICKS, STONES AND OTHER REFUSE SHALL BE REMOVED FROM THE SITE AND DISPOSED OF LEGALLY.
13. ALL EXISTING INACTIVE SEWER, WATER, GAS, ELECTRIC AND OTHER UTILITIES, WHICH INTERFERE WITH THE EXECUTION OF THE WORK, SHALL BE REMOVED AND/OR CAPPED, PLUGGED OR OTHERWISE DISCONTINUED AT POINTS WHICH WILL NOT INTERFERE WITH THE EXECUTION OF THE WORK, SUBJECT TO THE APPROVAL OF DISH Wireless L.L.C. AND TOWER OWNER, AND/OR LOCAL UTILITIES.
14. THE CONTRACTOR SHALL PROVIDE SITE SIGNAGE IN ACCORDANCE WITH THE TECHNICAL SPECIFICATION FOR SITE SIGNAGE REQUIRED BY LOCAL JURISDICTION AND SIGNAGE REQUIRED ON INDIVIDUAL PIECES OF EQUIPMENT, ROOMS, AND SHELTERS.
15. THE SITE SHALL BE GRADED TO CAUSE SURFACE WATER TO FLOW AWAY FROM THE CARRIER'S EQUIPMENT AND TOWER AREAS.
16. THE SUB GRADE SHALL BE COMPACTED AND BROUGHT TO A SMOOTH UNIFORM GRADE PRIOR TO FINISHED SURFACE APPLICATION.
17. THE AREAS OF THE OWNERS PROPERTY DISTURBED BY THE WORK AND NOT COVERED BY THE TOWER, EQUIPMENT OR DRIVEWAY, SHALL BE GRADED TO A UNIFORM SLOPE, AND STABILIZED TO PREVENT EROSION AS SPECIFIED ON THE CONSTRUCTION DRAWINGS AND/OR PROJECT SPECIFICATIONS.
18. CONTRACTOR SHALL MINIMIZE DISTURBANCE TO EXISTING SITE DURING CONSTRUCTION. EROSION CONTROL MEASURES, IF REQUIRED DURING CONSTRUCTION, SHALL BE IN CONFORMANCE WITH THE LOCAL GUIDELINES FOR EROSION AND SEDIMENT CONTROL.
19. THE CONTRACTOR SHALL PROTECT EXISTING IMPROVEMENTS, PAVEMENTS, CURBS, LANDSCAPING AND STRUCTURES. ANY DAMAGED PART SHALL BE REPAIRED AT CONTRACTOR'S EXPENSE TO THE SATISFACTION OF OWNER.
20. CONTRACTOR SHALL LEGALLY AND PROPERLY DISPOSE OF ALL SCRAP MATERIALS SUCH AS COAXIAL CABLES AND OTHER ITEMS REMOVED FROM THE EXISTING FACILITY. ANTENNAS AND RADIOS REMOVED SHALL BE RETURNED TO THE OWNER'S DESIGNATED LOCATION.
21. CONTRACTOR SHALL LEAVE PREMISES IN CLEAN CONDITION. TRASH AND DEBRIS SHOULD BE REMOVED FROM SITE ON A DAILY BASIS.
22. NO FILL OR EMBANKMENT MATERIAL SHALL BE PLACED ON FROZEN GROUND. FROZEN MATERIALS, SNOW OR ICE SHALL NOT BE PLACED IN ANY FILL OR EMBANKMENT.

GENERAL NOTES:

1. FOR THE PURPOSE OF CONSTRUCTION DRAWING, THE FOLLOWING DEFINITIONS SHALL APPLY:
CONTRACTOR: GENERAL CONTRACTOR RESPONSIBLE FOR CONSTRUCTION
CARRIER: DISH Wireless L.L.C.
TOWER OWNER: TOWER OWNER
2. THESE DRAWINGS HAVE BEEN PREPARED USING STANDARDS OF PROFESSIONAL CARE AND COMPLETENESS NORMALLY EXERCISED UNDER SIMILAR CIRCUMSTANCES BY REPUTABLE ENGINEERS IN THIS OR SIMILAR LOCALITIES. IT IS ASSUMED THAT THE WORK DEPICTED WILL BE PERFORMED BY AN EXPERIENCED CONTRACTOR AND/OR WORKPEOPLE WHO HAVE A WORKING KNOWLEDGE OF THE APPLICABLE CODE STANDARDS AND REQUIREMENTS AND OF INDUSTRY ACCEPTED STANDARD GOOD PRACTICE. AS NOT EVERY CONDITION OR ELEMENT IS (OR CAN BE) EXPLICITLY SHOWN ON THESE DRAWINGS, THE CONTRACTOR SHALL USE INDUSTRY ACCEPTED STANDARD GOOD PRACTICE FOR MISCELLANEOUS WORK NOT EXPLICITLY SHOWN.
3. THESE DRAWINGS REPRESENT THE FINISHED STRUCTURE. THEY DO NOT INDICATE THE MEANS OR METHODS OF CONSTRUCTION. THE CONTRACTOR SHALL BE SOLELY RESPONSIBLE FOR THE CONSTRUCTION MEANS, METHODS, TECHNIQUES, SEQUENCES, AND PROCEDURES. THE CONTRACTOR SHALL PROVIDE ALL MEASURES NECESSARY FOR PROTECTION OF LIFE AND PROPERTY DURING CONSTRUCTION. SUCH MEASURES SHALL INCLUDE, BUT NOT BE LIMITED TO, BRACING, FORMWORK, SHORING, ETC. SITE VISITS BY THE ENGINEER OR HIS REPRESENTATIVE WILL NOT INCLUDE INSPECTION OF THESE ITEMS AND IS FOR STRUCTURAL OBSERVATION OF THE FINISHED STRUCTURE ONLY.
4. NOTES AND DETAILS IN THE CONSTRUCTION DRAWINGS SHALL TAKE PRECEDENCE OVER GENERAL NOTES AND TYPICAL DETAILS. WHERE NO DETAILS ARE SHOWN, CONSTRUCTION SHALL CONFORM TO SIMILAR WORK ON THE PROJECT, AND/OR AS PROVIDED FOR IN THE CONTRACT DOCUMENTS. WHERE DISCREPANCIES OCCUR BETWEEN PLANS, DETAILS, GENERAL NOTES, AND SPECIFICATIONS, THE GREATER, MORE STRICT REQUIREMENTS, SHALL GOVERN. IF FURTHER CLARIFICATION IS REQUIRED CONTACT THE ENGINEER OF RECORD.
5. SUBSTANTIAL EFFORT HAS BEEN MADE TO PROVIDE ACCURATE DIMENSIONS AND MEASUREMENTS ON THE DRAWINGS TO ASSIST IN THE FABRICATION AND/OR PLACEMENT OF CONSTRUCTION ELEMENTS BUT IT IS THE SOLE RESPONSIBILITY OF THE CONTRACTOR TO FIELD VERIFY THE DIMENSIONS, MEASUREMENTS, AND/OR CLEARANCES SHOWN IN THE CONSTRUCTION DRAWINGS PRIOR TO FABRICATION OR CUTTING OF ANY NEW OR EXISTING CONSTRUCTION ELEMENTS. IF IT IS DETERMINED THAT THERE ARE DISCREPANCIES AND/OR CONFLICTS WITH THE CONSTRUCTION DRAWINGS THE ENGINEER OF RECORD IS TO BE NOTIFIED AS SOON AS POSSIBLE.
6. PRIOR TO THE SUBMISSION OF BIDS, THE BIDDING CONTRACTOR SHALL VISIT THE CELL SITE TO FAMILIARIZE WITH THE EXISTING CONDITIONS AND TO CONFIRM THAT THE WORK CAN BE ACCOMPLISHED AS SHOWN ON THE CONSTRUCTION DRAWINGS. ANY DISCREPANCY FOUND SHALL BE BROUGHT TO THE ATTENTION OF CARRIER POC AND TOWER OWNER.
7. ALL MATERIALS FURNISHED AND INSTALLED SHALL BE IN STRICT ACCORDANCE WITH ALL APPLICABLE CODES, REGULATIONS AND ORDINANCES. CONTRACTOR SHALL ISSUE ALL APPROPRIATE NOTICES AND COMPLY WITH ALL LAWS, ORDINANCES, RULES, REGULATIONS AND LAWFUL ORDERS OF ANY PUBLIC AUTHORITY REGARDING THE PERFORMANCE OF THE WORK. ALL WORK CARRIED OUT SHALL COMPLY WITH ALL APPLICABLE MUNICIPAL AND UTILITY COMPANY SPECIFICATIONS AND LOCAL JURISDICTIONAL CODES, ORDINANCES AND APPLICABLE REGULATIONS.
8. UNLESS NOTED OTHERWISE, THE WORK SHALL INCLUDE FURNISHING MATERIALS, EQUIPMENT, APPURTENANCES AND LABOR NECESSARY TO COMPLETE ALL INSTALLATIONS AS INDICATED ON THE DRAWINGS.
9. THE CONTRACTOR SHALL INSTALL ALL EQUIPMENT AND MATERIALS IN ACCORDANCE WITH MANUFACTURER'S RECOMMENDATIONS UNLESS SPECIFICALLY STATED OTHERWISE.
10. IF THE SPECIFIED EQUIPMENT CAN NOT BE INSTALLED AS SHOWN ON THESE DRAWINGS, THE CONTRACTOR SHALL PROPOSE AN ALTERNATIVE INSTALLATION FOR APPROVAL BY THE CARRIER AND TOWER OWNER PRIOR TO PROCEEDING WITH ANY SUCH CHANGE OF INSTALLATION.
11. CONTRACTOR IS TO PERFORM A SITE INVESTIGATION, BEFORE SUBMITTING BIDS, TO DETERMINE THE BEST ROUTING OF ALL CONDUITS FOR POWER, AND TELCO AND FOR GROUNDING CABLES AS SHOWN IN THE POWER, TELCO, AND GROUNDING PLAN DRAWINGS.
12. THE CONTRACTOR SHALL PROTECT EXISTING IMPROVEMENTS, PAVEMENTS, CURBS, LANDSCAPING AND STRUCTURES. ANY DAMAGED PART SHALL BE REPAIRED AT CONTRACTOR'S EXPENSE TO THE SATISFACTION OF DISH Wireless L.L.C. AND TOWER OWNER
13. CONTRACTOR SHALL LEGALLY AND PROPERLY DISPOSE OF ALL SCRAP MATERIALS SUCH AS COAXIAL CABLES AND OTHER ITEMS REMOVED FROM THE EXISTING FACILITY. ANTENNAS REMOVED SHALL BE RETURNED TO THE OWNER'S DESIGNATED LOCATION.
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PROJECT INFORMATION

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122 W. SENECA TURNPIKE
SYRACUSE, NY 13205

SHEET TITLE
GENERAL NOTES

SHEET NUMBER

GN-2

CONCRETE, FOUNDATIONS, AND REINFORCING STEEL:

- ALL CONCRETE WORK SHALL BE IN ACCORDANCE WITH THE ACI 301, ACI 318, ACI 336, ASTM A184, ASTM A185 AND THE DESIGN AND CONSTRUCTION SPECIFICATION FOR CAST-IN-PLACE CONCRETE.
- UNLESS NOTED OTHERWISE, SOIL BEARING PRESSURE USED FOR DESIGN OF SLABS AND FOUNDATIONS IS ASSUMED TO BE 1000 psf.
- ALL CONCRETE SHALL HAVE A MINIMUM COMPRESSIVE STRENGTH (f'c) OF 3000 psi AT 28 DAYS, UNLESS NOTED OTHERWISE. NO MORE THAN 90 MINUTES SHALL ELAPSE FROM BATCH TIME TO TIME OF PLACEMENT UNLESS APPROVED BY THE ENGINEER OF RECORD. TEMPERATURE OF CONCRETE SHALL NOT EXCEED 90°F AT TIME OF PLACEMENT.
- CONCRETE EXPOSED TO FREEZE-THAW CYCLES SHALL CONTAIN AIR ENTRAINING ADMIXTURES. AMOUNT OF AIR ENTRAINMENT TO BE BASED ON SIZE OF AGGREGATE AND F3 CLASS EXPOSURE (VERY SEVERE). CEMENT USED TO BE TYPE II PORTLAND CEMENT WITH A MAXIMUM WATER-TO-CEMENT RATIO (W/C) OF 0.45.
- ALL STEEL REINFORCING SHALL CONFORM TO ASTM A615. ALL WELDED WIRE FABRIC (WWF) SHALL CONFORM TO ASTM A185. ALL SPLICES SHALL BE CLASS "B" TENSION SPLICES, UNLESS NOTED OTHERWISE. ALL HOOKS SHALL BE STANDARD 90 DEGREE HOOKS, UNLESS NOTED OTHERWISE. YIELD STRENGTH (Fy) OF STANDARD DEFORMED BARS ARE AS FOLLOWS:
 #4 BARS AND SMALLER 40 ksi
 #5 BARS AND LARGER 60 ksi
- THE FOLLOWING MINIMUM CONCRETE COVER SHALL BE PROVIDED FOR REINFORCING STEEL UNLESS SHOWN OTHERWISE ON DRAWINGS:
 - CONCRETE CAST AGAINST AND PERMANENTLY EXPOSED TO EARTH 3"
 - CONCRETE EXPOSED TO EARTH OR WEATHER:
 - #6 BARS AND LARGER 2"
 - #5 BARS AND SMALLER 1-1/2"
 - CONCRETE NOT EXPOSED TO EARTH OR WEATHER:
 - SLAB AND WALLS 3/4"
 - BEAMS AND COLUMNS 1-1/2"
- A TOOLED EDGE OR A 3/4" CHAMFER SHALL BE PROVIDED AT ALL EXPOSED EDGES OF CONCRETE, UNLESS NOTED OTHERWISE, IN ACCORDANCE WITH ACI 301 SECTION 4.2.4.

ELECTRICAL INSTALLATION NOTES:

- ALL ELECTRICAL WORK SHALL BE PERFORMED IN ACCORDANCE WITH THE PROJECT SPECIFICATIONS, NEC AND ALL APPLICABLE FEDERAL, STATE, AND LOCAL CODES/ORDINANCES.
- CONDUIT ROUTINGS ARE SCHEMATIC. CONTRACTOR SHALL INSTALL CONDUITS SO THAT ACCESS TO EQUIPMENT IS NOT BLOCKED AND TRIP HAZARDS ARE ELIMINATED.
- WIRING, RACEWAY AND SUPPORT METHODS AND MATERIALS SHALL COMPLY WITH THE REQUIREMENTS OF THE NEC.
- ALL CIRCUITS SHALL BE SEGREGATED AND MAINTAIN MINIMUM CABLE SEPARATION AS REQUIRED BY THE NEC.
- ALL EQUIPMENT SHALL BEAR THE UNDERWRITERS LABORATORIES LABEL OF APPROVAL, AND SHALL CONFORM TO REQUIREMENT OF THE NATIONAL ELECTRICAL CODE.
- ALL OVERCURRENT DEVICES SHALL HAVE AN INTERRUPTING CURRENT RATING THAT SHALL BE GREATER THAN THE SHORT CIRCUIT CURRENT TO WHICH THEY ARE SUBJECTED, 22,000 AIC MINIMUM. VERIFY AVAILABLE SHORT CIRCUIT CURRENT DOES NOT EXCEED THE RATING OF ELECTRICAL EQUIPMENT IN ACCORDANCE WITH ARTICLE 110.24 NEC OR THE MOST CURRENT ADOPTED CODE PRE THE GOVERNING JURISDICTION.
- EACH END OF EVERY POWER PHASE CONDUCTOR, GROUNDING CONDUCTOR, AND TELCO CONDUCTOR OR CABLE SHALL BE LABELED WITH COLOR-CODED INSULATION OR ELECTRICAL TAPE (3M BRAND, 1/2" PLASTIC ELECTRICAL TAPE WITH UV PROTECTION, OR EQUAL). THE IDENTIFICATION METHOD SHALL CONFORM WITH NEC AND OSHA.
- ALL ELECTRICAL COMPONENTS SHALL BE CLEARLY LABELED WITH LAMICOID TAGS SHOWING THEIR RATED VOLTAGE, PHASE CONFIGURATION, WIRE CONFIGURATION, POWER OR AMPACITY RATING AND BRANCH CIRCUIT ID NUMBERS (i.e. PANEL BOARD AND CIRCUIT ID'S).
- PANEL BOARDS (ID NUMBERS) SHALL BE CLEARLY LABELED WITH PLASTIC LABELS.
- TIE WRAPS ARE NOT ALLOWED.
- ALL POWER AND EQUIPMENT GROUND WIRING IN TUBING OR CONDUIT SHALL BE SINGLE COPPER CONDUCTOR (#14 OR LARGER) WITH TYPE THHW, THWN, THWN-2, XHHW, XHHW-2, THW, THW-2, RHW, OR RHW-2 INSULATION UNLESS OTHERWISE SPECIFIED.
- SUPPLEMENTAL EQUIPMENT GROUND WIRING LOCATED INDOORS SHALL BE SINGLE COPPER CONDUCTOR (#6 OR LARGER) WITH TYPE THHW, THWN, THWN-2, XHHW, XHHW-2, THW, THW-2, RHW, OR RHW-2 INSULATION UNLESS OTHERWISE SPECIFIED.
- POWER AND CONTROL WIRING IN FLEXIBLE CORD SHALL BE MULTI-CONDUCTOR, TYPE SOOW CORD (#14 OR LARGER) UNLESS OTHERWISE SPECIFIED.
- POWER AND CONTROL WIRING FOR USE IN CABLE TRAY SHALL BE MULTI-CONDUCTOR, TYPE TC CABLE (#14 OR LARGER), WITH TYPE THHW, THWN, THWN-2, XHHW, XHHW-2, THW, THW-2, RHW, OR RHW-2 INSULATION UNLESS OTHERWISE SPECIFIED.
- ALL POWER AND GROUNDING CONNECTIONS SHALL BE CRIMP-STYLE, COMPRESSION WIRE LUGS AND WIRE NUTS BY THOMAS AND BETTS (OR EQUAL). LUGS AND WIRE NUTS SHALL BE RATED FOR OPERATION NOT LESS THAN 75° C (90° C IF AVAILABLE).
- RACEWAY AND CABLE TRAY SHALL BE LISTED OR LABELED FOR ELECTRICAL USE IN ACCORDANCE WITH NEMA, UL, ANSI/IEEE AND NEC.
- ELECTRICAL METALLIC TUBING (EMT), INTERMEDIATE METAL CONDUIT (IMC), OR RIGID METAL CONDUIT (RMC) SHALL BE USED FOR EXPOSED INDOOR LOCATIONS.

- ELECTRICAL METALLIC TUBING (EMT) OR METAL-CLAD CABLE (MC) SHALL BE USED FOR CONCEALED INDOOR LOCATIONS.
- SCHEDULE 40 PVC UNDERGROUND ON STRAIGHTS AND SCHEDULE 80 PVC FOR ALL ELBOWS/90s AND ALL APPROVED ABOVE GRADE PVC CONDUIT.
- LIQUID-TIGHT FLEXIBLE METALLIC CONDUIT (LIQUID-TITE FLEX) SHALL BE USED INDOORS AND OUTDOORS, WHERE VIBRATION OCCURS OR FLEXIBILITY IS NEEDED.
- CONDUIT AND TUBING FITTINGS SHALL BE THREADED OR COMPRESSION-TYPE AND APPROVED FOR THE LOCATION USED. SET SCREW FITTINGS ARE NOT ACCEPTABLE.
- CABINETS, BOXES AND WIRE WAYS SHALL BE LABELED FOR ELECTRICAL USE IN ACCORDANCE WITH NEMA, UL, ANSI/IEEE AND THE NEC.
- WIREWAYS SHALL BE METAL WITH AN ENAMEL FINISH AND INCLUDE A HINGED COVER, DESIGNED TO SWING OPEN DOWNWARDS (WIREMOLD SPECMATE WIREWAY).
- SLOTTED WIRING DUCT SHALL BE PVC AND INCLUDE COVER (PANDUIT TYPE E OR EQUAL).
- CONDUITS SHALL BE FASTENED SECURELY IN PLACE WITH APPROVED NON-PERFORATED STRAPS AND HANGERS. EXPLOSIVE DEVICES (i.e. POWDER-ACTUATED) FOR ATTACHING HANGERS TO STRUCTURE WILL NOT BE PERMITTED. CLOSELY FOLLOW THE LINES OF THE STRUCTURE, MAINTAIN CLOSE PROXIMITY TO THE STRUCTURE AND KEEP CONDUITS IN TIGHT ENVELOPES. CHANGES IN DIRECTION TO ROUTE AROUND OBSTACLES SHALL BE MADE WITH CONDUIT OUTLET BODIES. CONDUIT SHALL BE INSTALLED IN A NEAT AND WORKMANLIKE MANNER. PARALLEL AND PERPENDICULAR TO STRUCTURE WALL AND CEILING LINES. ALL CONDUIT SHALL BE FISHED TO CLEAR OBSTRUCTIONS. ENDS OF CONDUITS SHALL BE TEMPORARILY CAPPED FLUSH TO FINISH GRADE TO PREVENT CONCRETE, PLASTER OR DIRT FROM ENTERING. CONDUITS SHALL BE RIGIDLY CLAMPED TO BOXES BY GALVANIZED MALLEABLE IRON BUSHING ON INSIDE AND GALVANIZED MALLEABLE IRON LOCKNUT ON OUTSIDE AND INSIDE.
- EQUIPMENT CABINETS, TERMINAL BOXES, JUNCTION BOXES AND PULL BOXES SHALL BE GALVANIZED OR EPOXY-COATED SHEET STEEL. SHALL MEET OR EXCEED UL 50 AND BE RATED NEMA 1 (OR BETTER) FOR INTERIOR LOCATIONS AND NEMA 3 (OR BETTER) FOR EXTERIOR LOCATIONS.
- METAL RECEPTACLE, SWITCH AND DEVICE BOXES SHALL BE GALVANIZED, EPOXY-COATED OR NON-CORRODING; SHALL MEET OR EXCEED UL 514A AND NEMA OS 1 AND BE RATED NEMA 1 (OR BETTER) FOR INTERIOR LOCATIONS AND WEATHER PROTECTED (WP OR BETTER) FOR EXTERIOR LOCATIONS.
- NONMETALLIC RECEPTACLE, SWITCH AND DEVICE BOXES SHALL MEET OR EXCEED NEMA OS 2 (NEWEST REVISION) AND BE RATED NEMA 1 (OR BETTER) FOR INTERIOR LOCATIONS AND WEATHER PROTECTED (WP OR BETTER) FOR EXTERIOR LOCATIONS.
- THE CONTRACTOR SHALL NOTIFY AND OBTAIN NECESSARY AUTHORIZATION FROM THE CARRIER AND/OR DISH Wireless L.L.C. AND TOWER OWNER BEFORE COMMENCING WORK ON THE AC POWER DISTRIBUTION PANELS.
- THE CONTRACTOR SHALL PROVIDE NECESSARY TAGGING ON THE BREAKERS, CABLES AND DISTRIBUTION PANELS IN ACCORDANCE WITH THE APPLICABLE CODES AND STANDARDS TO SAFEGUARD LIFE AND PROPERTY.
- INSTALL LAMICOID LABEL ON THE METER CENTER TO SHOW "DISH Wireless L.L.C."
- ALL EMPTY/SPARE CONDUITS THAT ARE INSTALLED ARE TO HAVE A METERED MULE TAPE PULL CORD INSTALLED.



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N.Y. C.O.A.#: 0017609

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DRAWN BY:	CHECKED BY:	APPROVED BY:
AF	DR	MPC

RFDS REV #: 0

CONSTRUCTION DOCUMENTS

SUBMITTALS		
REV	DATE	DESCRIPTION
A	07/15/2021	ISSUED FOR REVIEW
0	08/11/2021	ISSUED FOR CONSTRUCTION

A&E PROJECT NUMBER
20933018A

DISH Wireless L.L.C.
PROJECT INFORMATION
SYSYR00355B
122 W. SENECA TURNPIKE
SYRACUSE, NY 13205

SHEET TITLE
GENERAL NOTES

SHEET NUMBER
GN-3

GROUNDING NOTES:

1. ALL GROUND ELECTRODE SYSTEMS (INCLUDING TELECOMMUNICATION, RADIO, LIGHTNING PROTECTION AND AC POWER GES'S) SHALL BE BONDED TOGETHER AT OR BELOW GRADE, BY TWO OR MORE COPPER BONDING CONDUCTORS IN ACCORDANCE WITH THE NEC.
2. THE CONTRACTOR SHALL PERFORM IEEE FALL-OF-POTENTIAL RESISTANCE TO EARTH TESTING (PER IEEE 1100 AND 81) FOR GROUND ELECTRODE SYSTEMS, THE CONTRACTOR SHALL FURNISH AND INSTALL SUPPLEMENTAL GROUND ELECTRODES AS NEEDED TO ACHIEVE A TEST RESULT OF 5 OHMS OR LESS.
3. THE CONTRACTOR IS RESPONSIBLE FOR PROPERLY SEQUENCING GROUNDING AND UNDERGROUND CONDUIT INSTALLATION AS TO PREVENT ANY LOSS OF CONTINUITY IN THE GROUNDING SYSTEM OR DAMAGE TO THE CONDUIT AND PROVIDE TESTING RESULTS.
4. METAL CONDUIT AND TRAY SHALL BE GROUNDED AND MADE ELECTRICALLY CONTINUOUS WITH LISTED BONDING FITTINGS OR BY BONDING ACROSS THE DISCONTINUITY WITH #6 COPPER WIRE UL APPROVED GROUNDING TYPE CONDUIT CLAMPS.
5. METAL RACEWAY SHALL NOT BE USED AS THE NEC REQUIRED EQUIPMENT GROUND CONDUCTOR. STRANDED COPPER CONDUCTORS WITH GREEN INSULATION, SIZED IN ACCORDANCE WITH THE NEC, SHALL BE FURNISHED AND INSTALLED WITH THE POWER CIRCUITS TO BTS EQUIPMENT.
6. EACH CABINET FRAME SHALL BE DIRECTLY CONNECTED TO THE MASTER GROUND BAR WITH GREEN INSULATED SUPPLEMENTAL EQUIPMENT GROUND WIRES, #6 STRANDED COPPER OR LARGER FOR INDOOR BTS; #2 BARE SOLID TINNED COPPER FOR OUTDOOR BTS.
7. CONNECTIONS TO THE GROUND BUS SHALL NOT BE DOUBLED UP OR STACKED BACK TO BACK CONNECTIONS ON OPPOSITE SIDE OF THE GROUND BUS ARE PERMITTED.
8. ALL EXTERIOR GROUND CONDUCTORS BETWEEN EQUIPMENT/GROUND BARS AND THE GROUND RING SHALL BE #2 SOLID TINNED COPPER UNLESS OTHERWISE INDICATED.
9. ALUMINUM CONDUCTOR OR COPPER CLAD STEEL CONDUCTOR SHALL NOT BE USED FOR GROUNDING CONNECTIONS.
10. USE OF 90° BENDS IN THE PROTECTION GROUNDING CONDUCTORS SHALL BE AVOIDED WHEN 45° BENDS CAN BE ADEQUATELY SUPPORTED.
11. EXOTHERMIC WELDS SHALL BE USED FOR ALL GROUNDING CONNECTIONS BELOW GRADE.
12. ALL GROUND CONNECTIONS ABOVE GRADE (INTERIOR AND EXTERIOR) SHALL BE FORMED USING HIGH PRESS CRIMPS.
13. COMPRESSION GROUND CONNECTIONS MAY BE REPLACED BY EXOTHERMIC WELD CONNECTIONS.
14. ICE BRIDGE BONDING CONDUCTORS SHALL BE EXOTHERMICALLY BONDED OR BOLTED TO THE BRIDGE AND THE TOWER GROUND BAR.
15. APPROVED ANTIOXIDANT COATINGS (i.e. CONDUCTIVE GEL OR PASTE) SHALL BE USED ON ALL COMPRESSION AND BOLTED GROUND CONNECTIONS.
16. ALL EXTERIOR GROUND CONNECTIONS SHALL BE COATED WITH A CORROSION RESISTANT MATERIAL.
17. MISCELLANEOUS ELECTRICAL AND NON-ELECTRICAL METAL BOXES, FRAMES AND SUPPORTS SHALL BE BONDED TO THE GROUND RING, IN ACCORDANCE WITH THE NEC.
18. BOND ALL METALLIC OBJECTS WITHIN 6 ft OF MAIN GROUND RING WITH (1) #2 BARE SOLID TINNED COPPER GROUND CONDUCTOR.
19. GROUND CONDUCTORS USED FOR THE FACILITY GROUNDING AND LIGHTNING PROTECTION SYSTEMS SHALL NOT BE ROUTED THROUGH METALLIC OBJECTS THAT FORM A RING AROUND THE CONDUCTOR, SUCH AS METALLIC CONDUITS, METAL SUPPORT CLIPS OR SLEEVES THROUGH WALLS OR FLOORS. WHEN IT IS REQUIRED TO BE HOUSED IN CONDUIT TO MEET CODE REQUIREMENTS OR LOCAL CONDITIONS, NON-METALLIC MATERIAL SUCH AS PVC CONDUIT SHALL BE USED. WHERE USE OF METAL CONDUIT IS UNAVOIDABLE (i.e., NONMETALLIC CONDUIT PROHIBITED BY LOCAL CODE) THE GROUND CONDUCTOR SHALL BE BONDED TO EACH END OF THE METAL CONDUIT.
20. ALL GROUNDS THAT TRANSITION FROM BELOW GRADE TO ABOVE GRADE MUST BE #2 BARE SOLID TINNED COPPER IN 3/4" NON-METALLIC, FLEXIBLE CONDUIT FROM 24" BELOW GRADE TO WITHIN 3" TO 6" OF CAD-WELD TERMINATION POINT. THE EXPOSED END OF THE CONDUIT MUST BE SEALED WITH SILICONE CAULK. (ADD TRANSITIONING GROUND STANDARD DETAIL AS WELL).
21. BUILDINGS WHERE THE MAIN GROUNDING CONDUCTORS ARE REQUIRED TO BE ROUTED TO GRADE, THE CONTRACTOR SHALL ROUTE TWO GROUNDING CONDUCTORS FROM THE ROOFTOP, TOWERS, AND WATER TOWERS GROUNDING RING, TO THE EXISTING GROUNDING SYSTEM, THE GROUNDING CONDUCTORS SHALL NOT BE SMALLER THAN 2/0 COPPER. ROOFTOP GROUNDING RING SHALL BE BONDED TO THE EXISTING GROUNDING SYSTEM, THE BUILDING STEEL COLUMNS, LIGHTNING PROTECTION SYSTEM, AND BUILDING MAIN WATER LINE (FERROUS OR NONFERROUS METAL PIPING ONLY). DO NOT ATTACH GROUNDING TO FIRE SPRINKLER SYSTEM PIPES.



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DRAWN BY: CHECKED BY: APPROVED BY:

AF DR MPC

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SHEET TITLE
GENERAL NOTES

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GN-4


Zoning Coverage Plots SYSYR00355B

07-20-2021

dish wireless



Zoning Coverage Plots

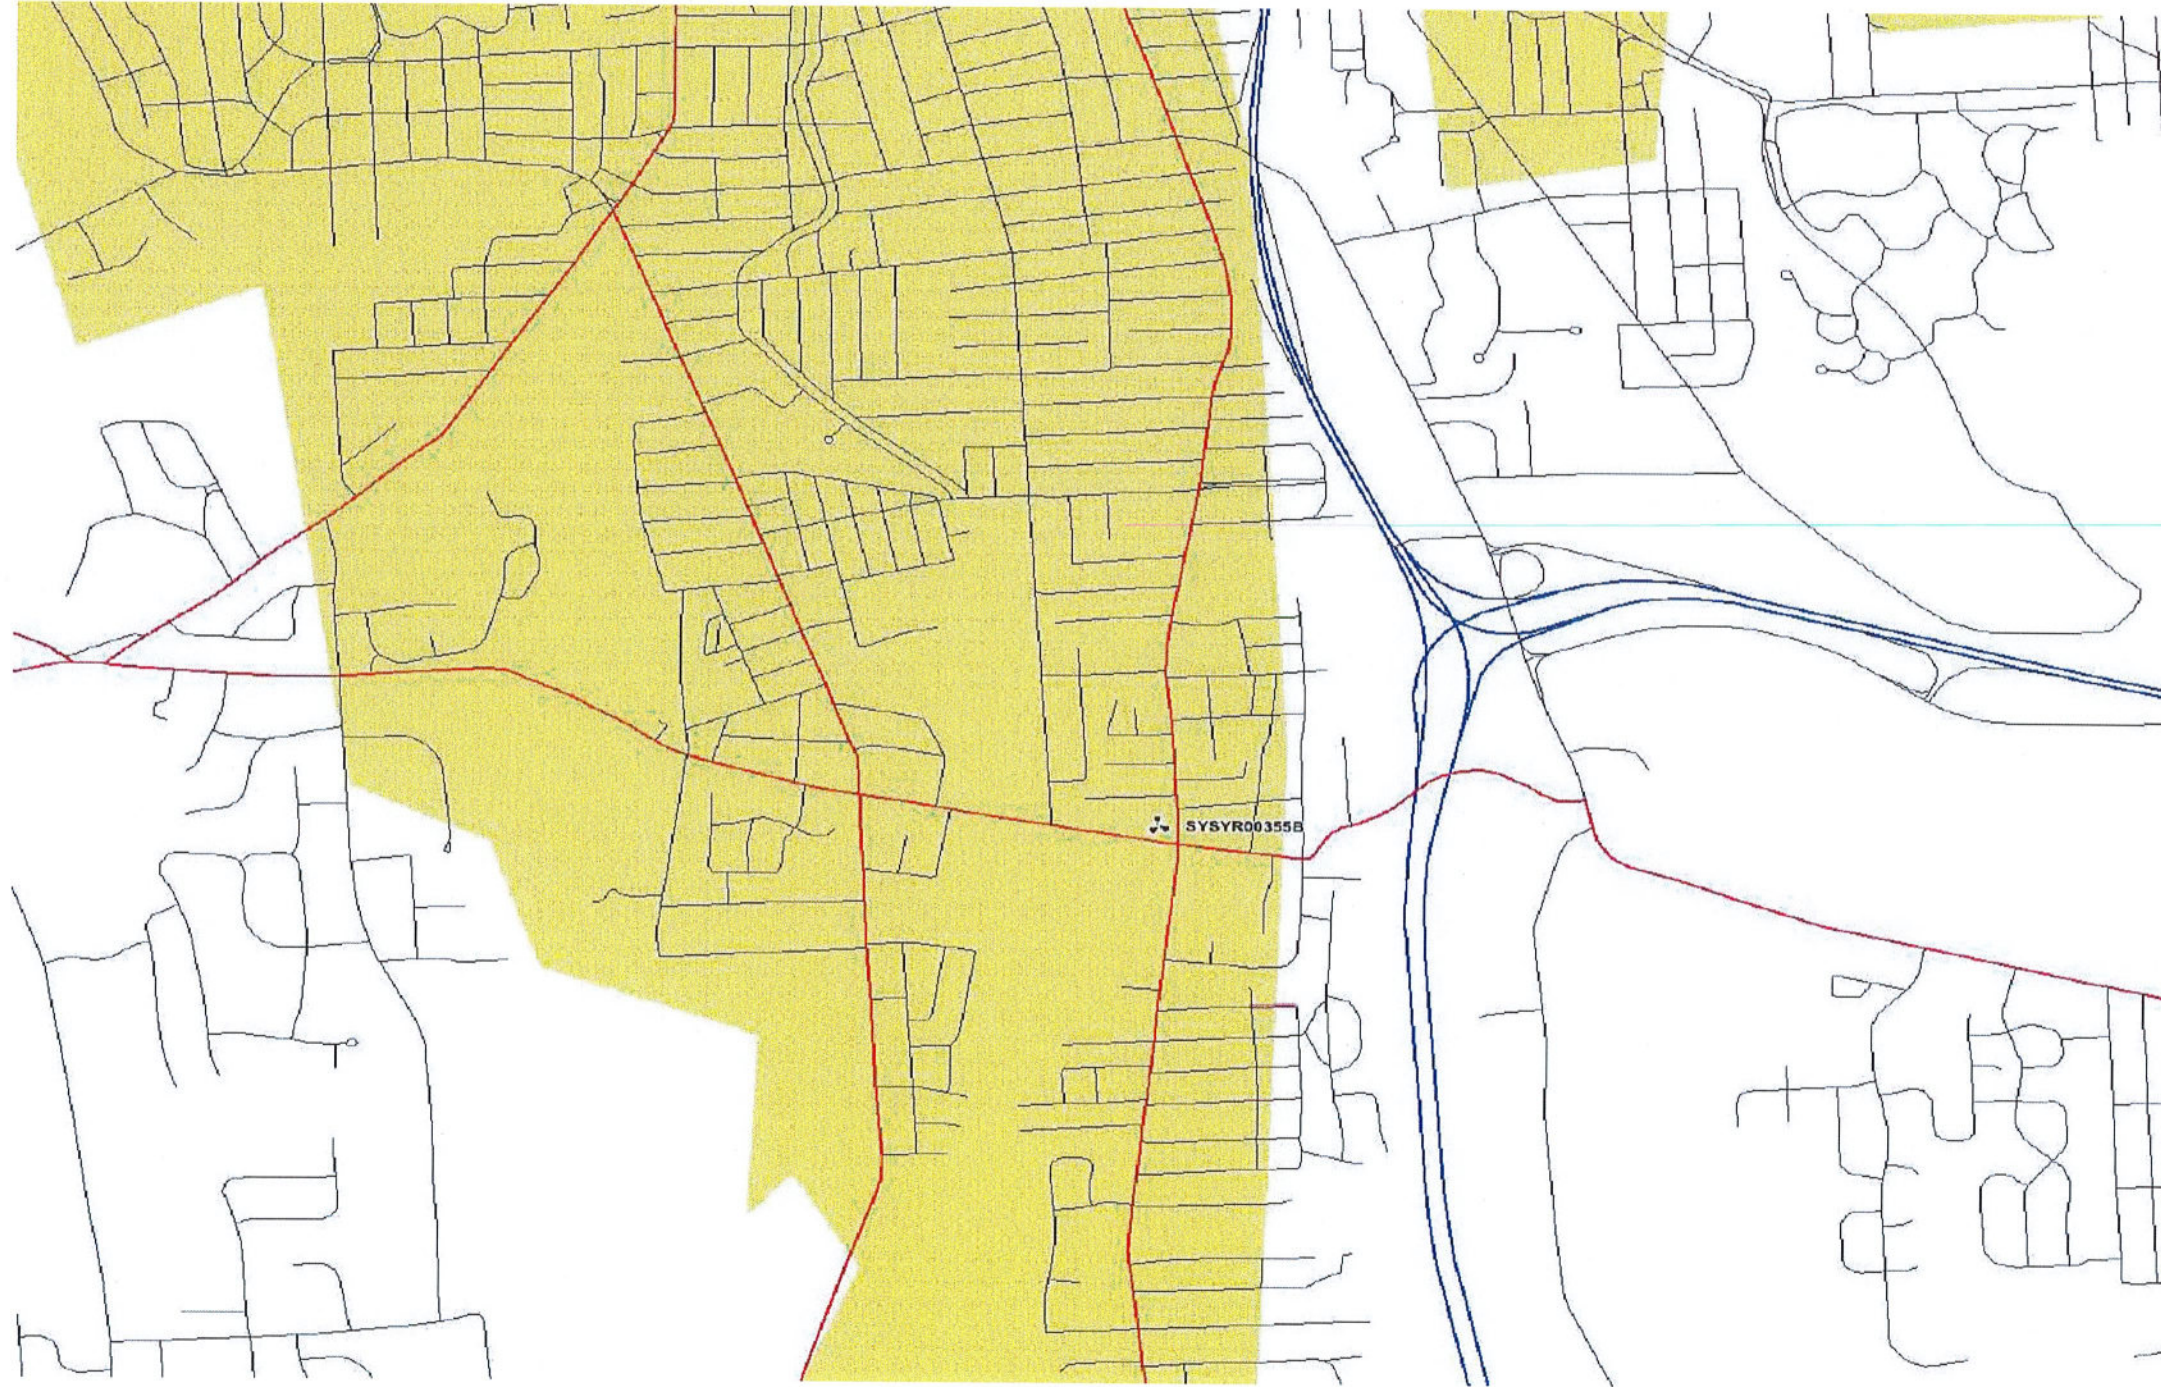

Site ID

Date


Coverage plot (n66) without
SYSYR00355B.

RSRP (dBm)

- 98.2 to -20
- 103.2 to -98.2
- 115.2 to -103.2



Zoning Coverage Plots

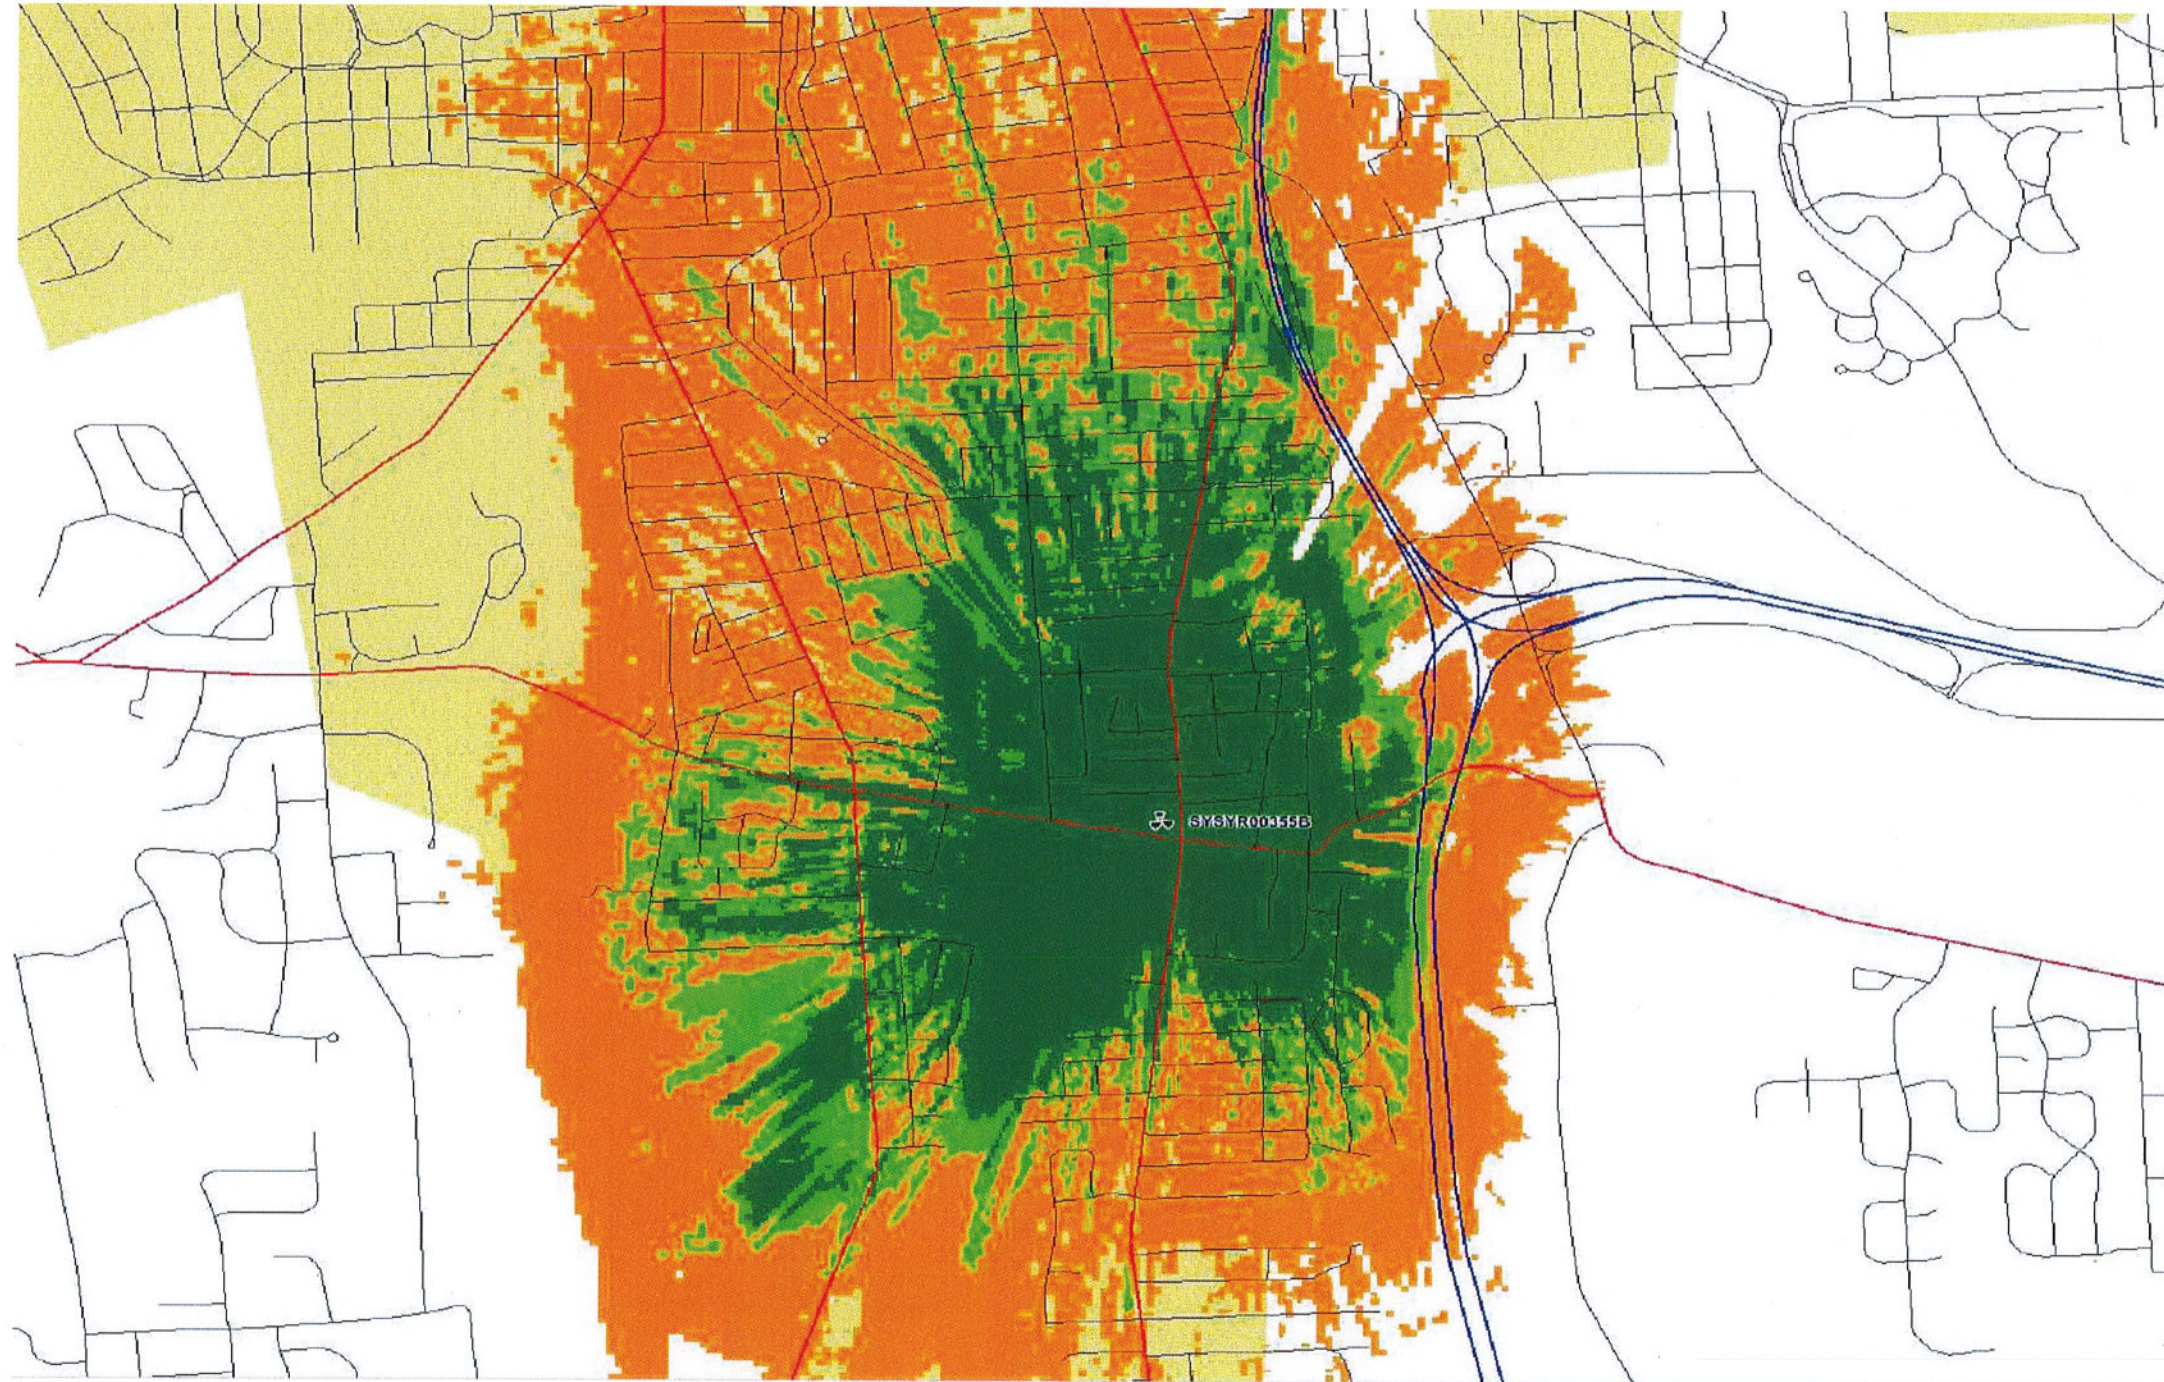




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Coverage plot (n66) with
SYSYR00355B.

RSRP (dBm)

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