

Certificate of Appropriateness Application

Case Number: CA-19-01

Submit by mail or by hand to:

Syracuse Landmark Preservation Board City Hall Commons, Room 512 201 E. Washington Street Syracuse, NY 13202

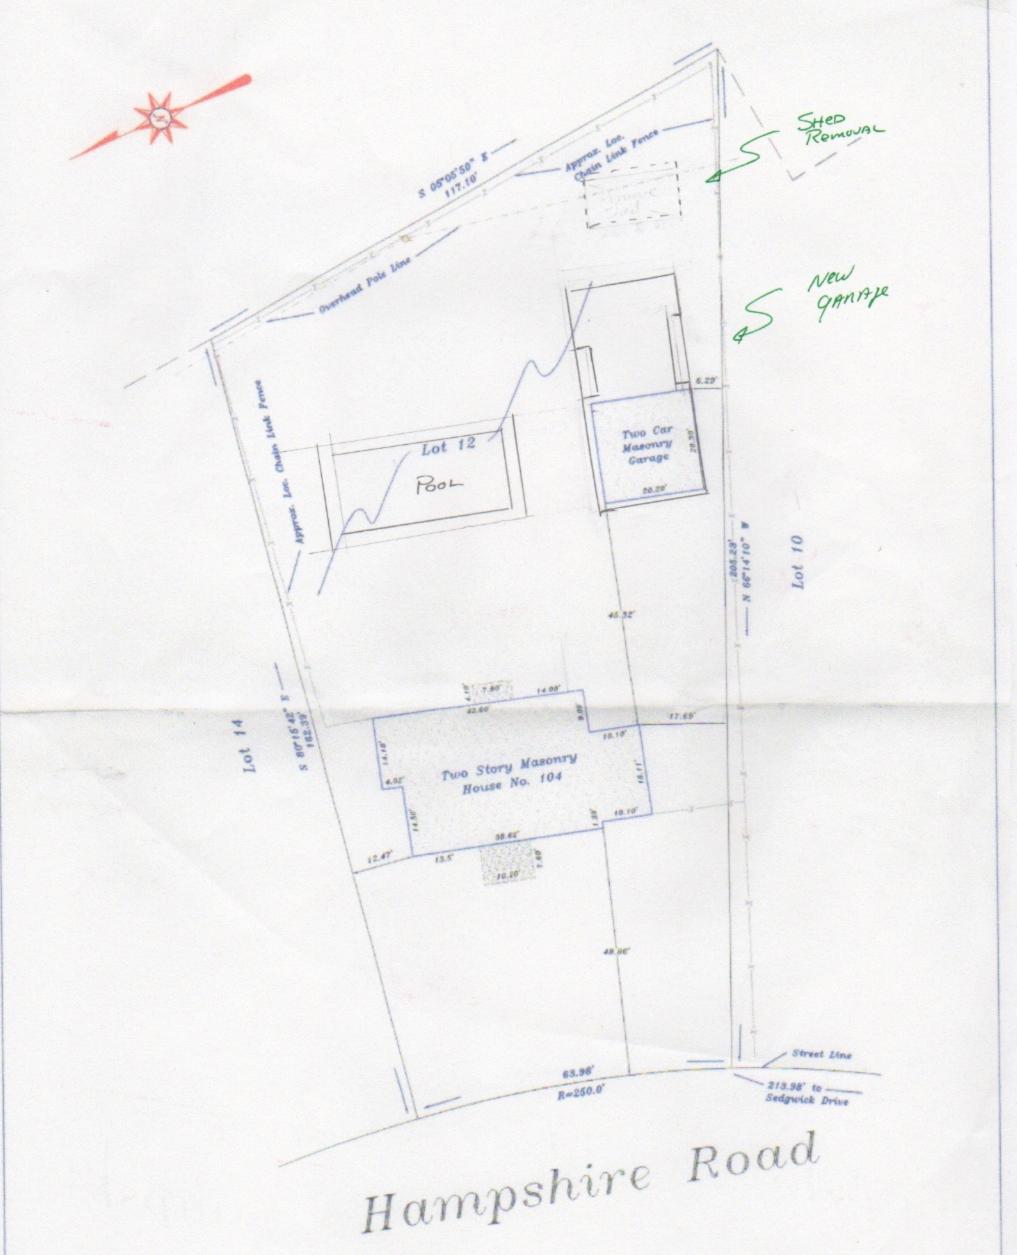
Electronic submissions to: SLPB@syrgov.net

APPI	LICATI	<u>ON</u>			
I.		cant's Name: Shawn Charleve Patane ss: 104 Hampshine Rd 54RACUSE NY 13203			
		: 315 345-6436 email: patane family eme. com			
II.	Work is proposed for property at (address): 104 Hampshine Ps				
	Th	is property is:			
		individual Protected Site			
	Ø	located within a Preservation District			
III.	indica	pplication is for the following (check as many as appropriate; complete only the parts ted with each work item):  Partial or complete demolition (Complete Part 1)  Alteration to texture or material composition of building exterior (Complete Part 2)  Alteration to texture or material composition of building interior (only if interior is designated a Protected Site; Complete Part 2)  Change in color (Complete Part 3)  Cleaning (Complete Part 3)			
		Addition to existing building (Complete Part 4)			
		New building construction (Complete Part 4)			
		Alteration to site including excavation, change in land contours, installation of pavemen for parking lots, driveways, or sidewalks (Complete Part 5)			
		Deposit of refuse or waste material (Complete Part 5)			
		Change in signage or advertising (Complete Part 6)			
Appli	cant's S	ignature: Date:			
Owne	er's Sign	ature: Date: 3/15/19,			

\*Submission of this application or approval of a Certificate of Appropriateness does not relieve the applicant of his/her responsibilities in obtaining other permits and/or approvals as prescribed by law. The Syracuse Landmark Preservation Board uses the United States Secretary of the Interior's Standards as guidelines for review of proposals. A copy of these standards is available at the SLPB office or online at <a href="http://www.nps.gov/hps/tps/standguide/">http://www.nps.gov/hps/tps/standguide/</a>.

Has an order for demolition of the structure been issued by the Division of Code Enforcemen Chief of Fire, or another agency of the City of Syracuse?  No Yes  Please indicate the date when order was issued: Please indicate the issuing department or agency:  Certificate of Appropriateness is being sought for: Complete demolition Partial Demolition — Enclose site plan showing portions to be removed and photograp of existing structure.  1-3 Why is the demolition necessary?  List any other factors or information that you feel should be considered by the Syracuse Landmark Preservation Board:	olition:	Part 1 Prior Application
Please indicate the issuing department or agency:  Certificate of Appropriateness is being sought for:  Complete demolition  Partial Demolition – Enclose site plan showing portions to be removed and photograp of existing structure.  1-3 Why is the demolition necessary?  List any other factors or information that you feel should be considered by the Syracuse	Chief	of Fire, or another agency of the City of Syracuse?  No
□ Complete demolition □ Partial Demolition − Enclose site plan showing portions to be removed and photograp of existing structure.  1-3 Why is the demolition necessary?		
List any other factors or information that you feel should be considered by the Syracuse		Complete demolition  Partial Demolition – Enclose site plan showing portions to be removed and photographed and photographed provides the plan showing portion of the provides and photographed provides
List any other factors or information that you feel should be considered by the Syracuse	1-3	Why is the demolition necessary?
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Clea	Cleaning/Painting: Part 3				
3-1	This application is for:  Painting of building exterior  Cleaning of building exterior  Painting of building interior (only of interior is designated).  Cleaning of building interior (only if interior is designated).				
3-2	The components to be painted and/or cleaned are made of:				
3-3	The cleaning process that is being proposed is:				
3-4	Do new colors match a previous color scheme?  Yes No Please submit color chips of proposed colors if proposed colors are different from existing scheme.				
Addi	tional/New Construction: Part 4				
4-1	This application is for:  Addition to existing structure Construction of new building				
4-2	Is proposed addition or new construction in public view from neighboring streets?  Yes No				
4-3	What is the purpose of the purposed addition or new building?				
4-4	Describe how the new construction is compatible in scale, materials, and texture to the design of the existing structure and the character of surrounding buildings:  SANAGE HAS BEEN CLESIGNED TO DIESENT ITSELT TO HAMPS hine Rd (The only Road it is Usible from) IN Substantially Similar tashion to the ganage being replaced Windows and downs selected to be of Guality materials similar in scale to existing windows,				
4-5	Submit a site plan, elevation drawings and a materials list for the new construction.				



To: Kiley Law Firm. P.C.
: Monroe Title Insurance Corporation
: Shawn K. and Charlene A. Patane
: Devorsetz, Stinziano, Gilberti, Heintz & Smith. P.C.
: GMAC Mortgage Corporation, it's successors and/or assigns

I hereby certify that this map was made from an actual survey and same is correct

Licensed Land Surveyor New Y

R.J. Lighton Sr. NYSLS 45373 886 E. Brighton Ave., Syracuse N.Y. 13205 Location survey on Lot #12, Block #6, Sedgwick Farm Tract.

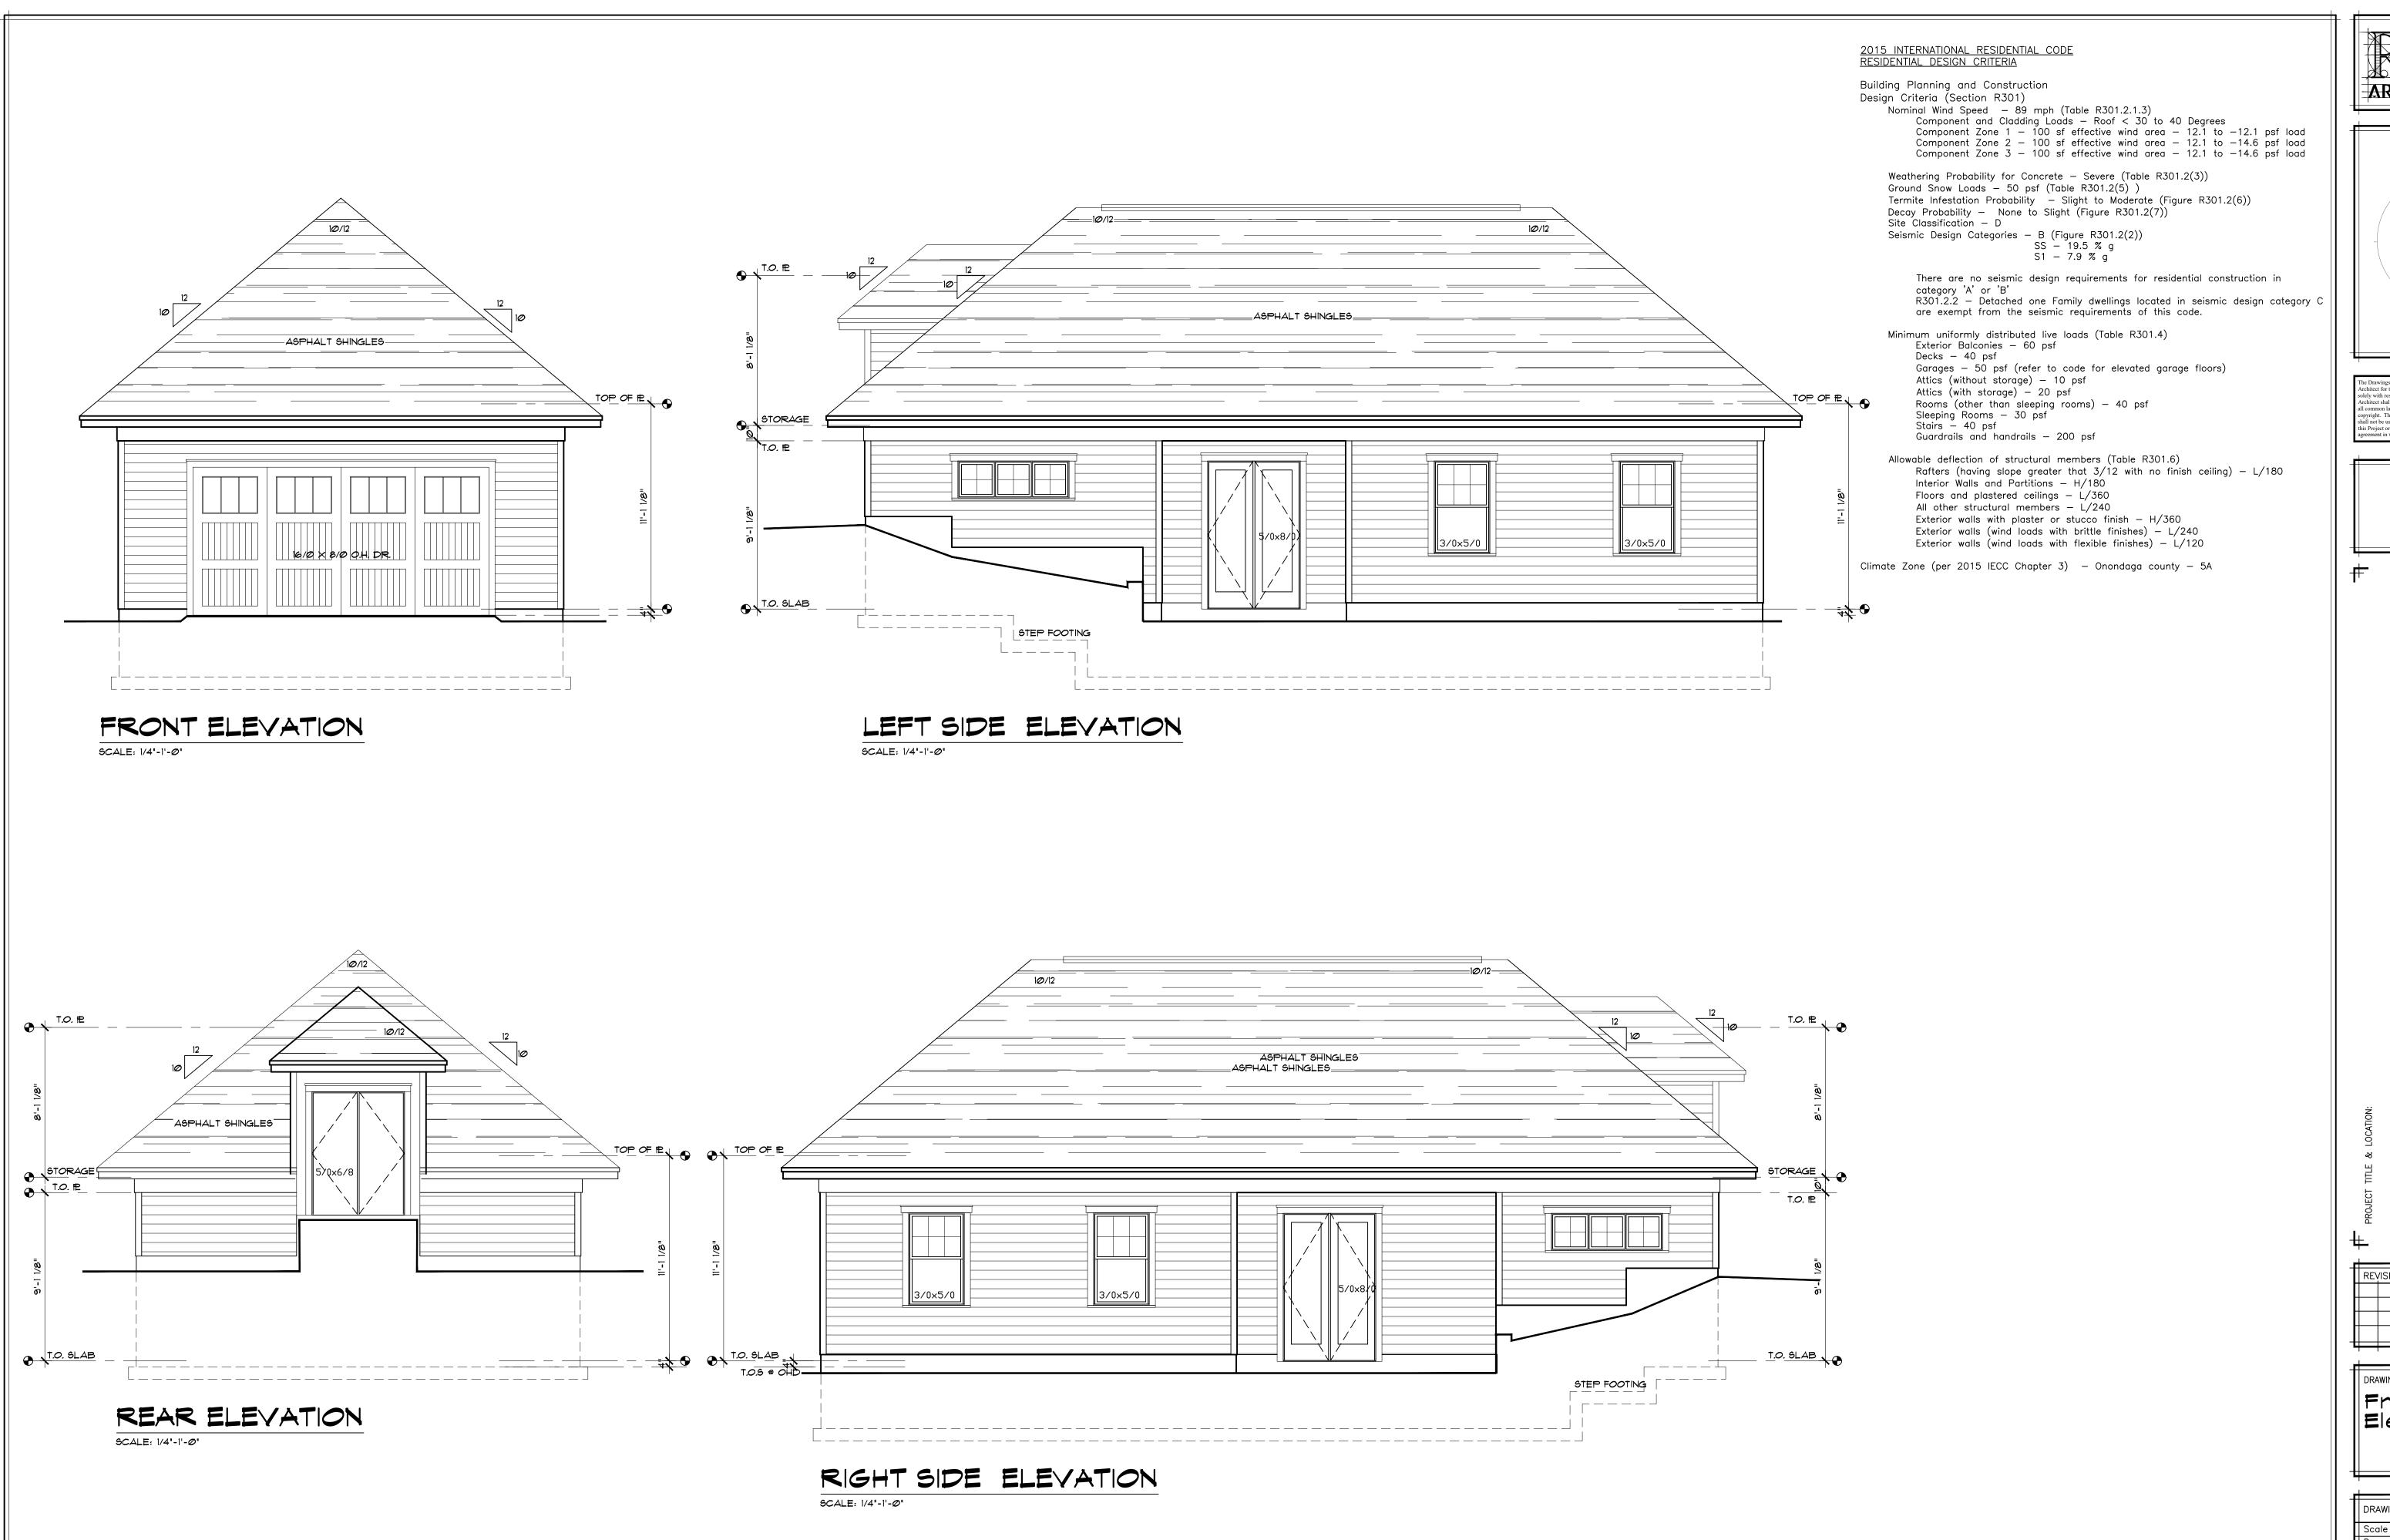
Known as No. 104 Hampshire Road, City of Syracuse, County of Onondaga and State of New York.

Drawn by: RjL Scale: 1"=20' Date: 4-01-02


Revisions:








ARCHITECT P.C.

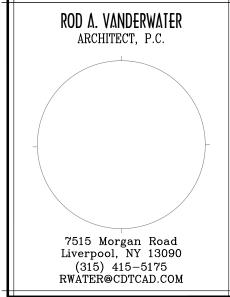

The Drawings, Specifications and other documents prepared by the Architect for this Project are instruments of the Architect's service for use solely with respect to this Project and, unless otherwise provided, the Architect shall be deemed the author of these documents and shall retain all common law, statutory and other reserved rights, including the copyright. The Architect's Drawings, Specifications or other documents shall not be used by the Owner or others on other projects, for additions to this Project or for completion of this Project by others except by agreement in writing from the Architect.

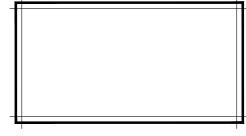

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Patane Garag 104 Hampshire Road Syracuse, NY 13203

PROJECT TITLE & LOCATION:

REVISIONS

DRAWING TITLE

Front & Rear

Elevation

DRAWING INFORMATION

Scale 1/4" = 1'-0"


Drawn CDT

Checked RY

| Checked | RY | Date | Ø1-16-19 | Job No. | 19-006 |

DRAWING NUMBER

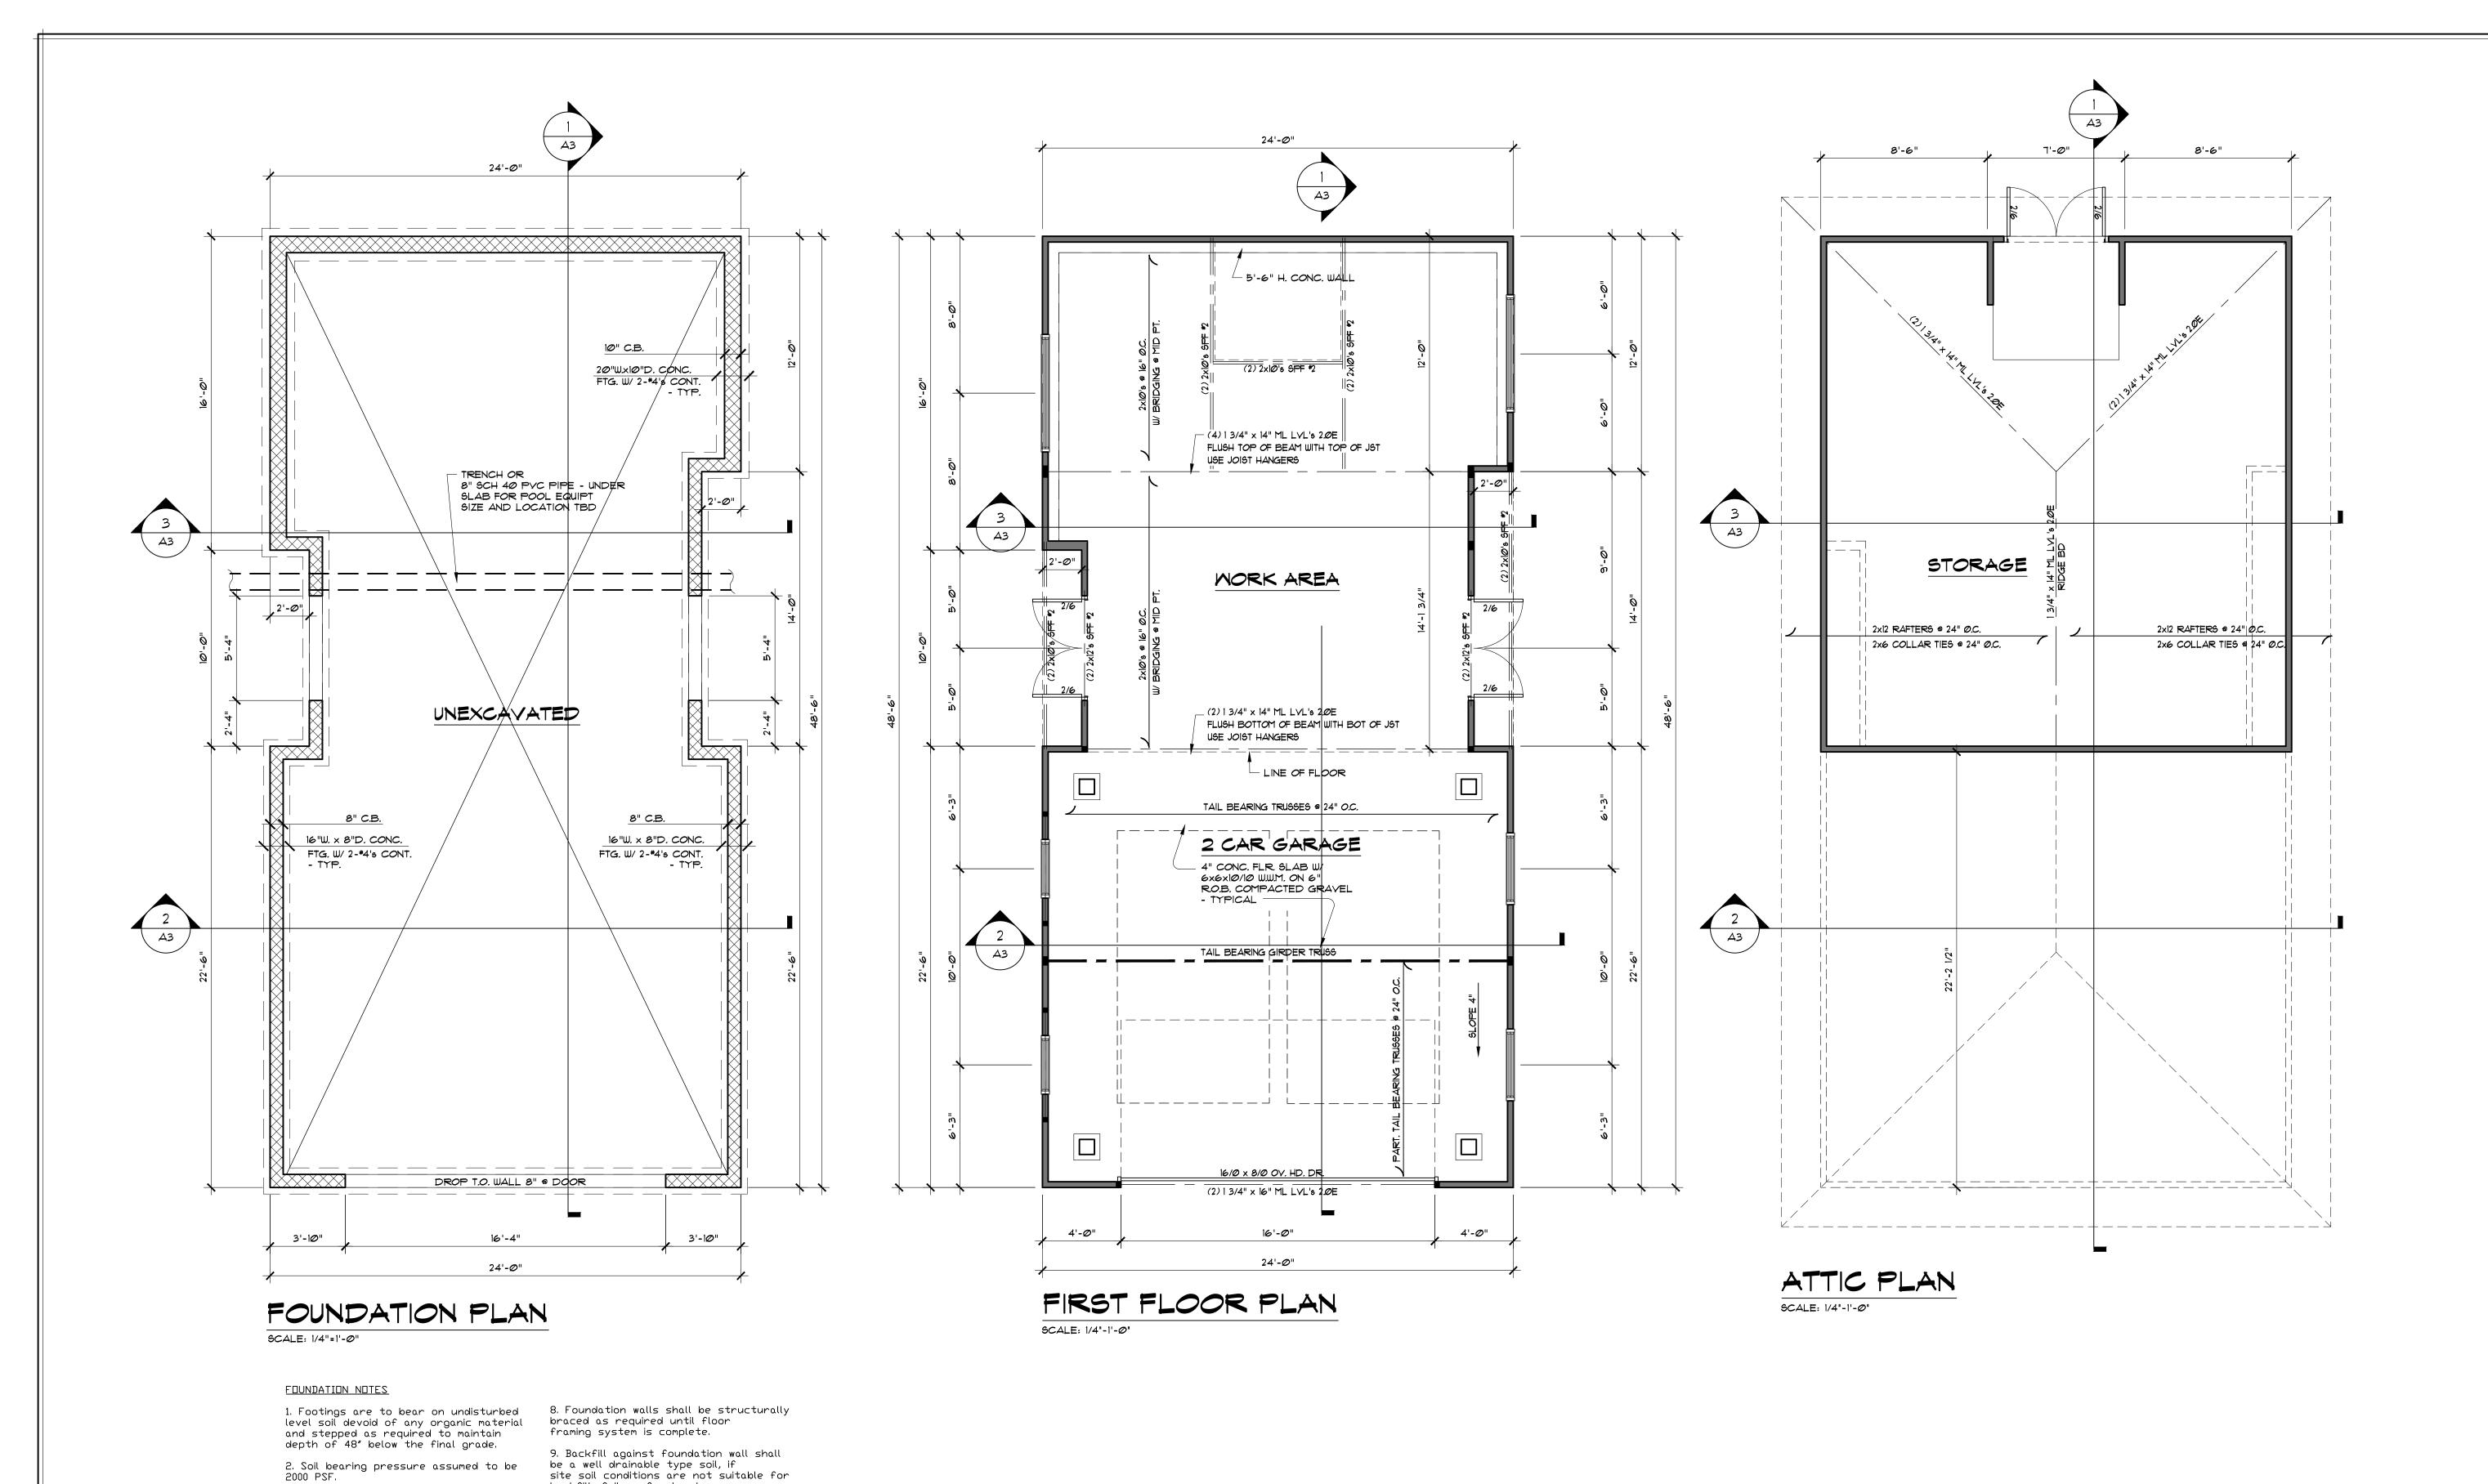PROGRESS SET - ISSUED 03-12-19
NOT FOR CONSTRUCTION



site soil conditions are not suitable for

NYSDOT specifications Item #304.2.02 type

material shall be placed in several lifts.

10. Run outside perimeter drain to Daylight. Provide stone riprap @ out fall of pipe. If grade will not permit

daylighting of pipe see "alternate drainage Detail".

11. Minimum Specified compressive strength of Concrete:

Basement walls, Foundations, and

concrete not exposed to weather

grade except garage floor slabs

Basement walls, Foundations, and

Porches, carport slabs and steps exposed to weather and garage floor

2500 psi Concrete

3000 psi Concrete.

3500 psi Concrete.

Basement Slabs and interior slabs on

vertical concrete exposed to weather

backfill, foil conforming to

4 shall be used. Backfill

3. Any fill under grade supported slabs to be a minimum of 4" thick granular material compacted to 90%.

5. All wood in contact with concrete to

6. Beam pockets in foundation walls to

have 1/2" of air space at sides and ends with a minimum bearing of 4". Fill block solid full ht. UNDER beam bearing.

7. Foundation walls shall be provided with dampproofing or waterproofing material. Dampproofing used where

hydrostatic pressure will not occur

pressure may exist. The type

system/ material used shall be

determined by site conditions.

and waterproofing where hydrostatic

4. Concrete slabs to have control joints at 16' (maximum) intervals each way. Provide 6 mil poly under slabs on

be pressure treated.

ROD A. VANDERWATER ARCHITECT, P.C. 7515 Morgan Road Liverpool, NY 13090 (315) 415-5175RWÀTER@CDTCAD.COM

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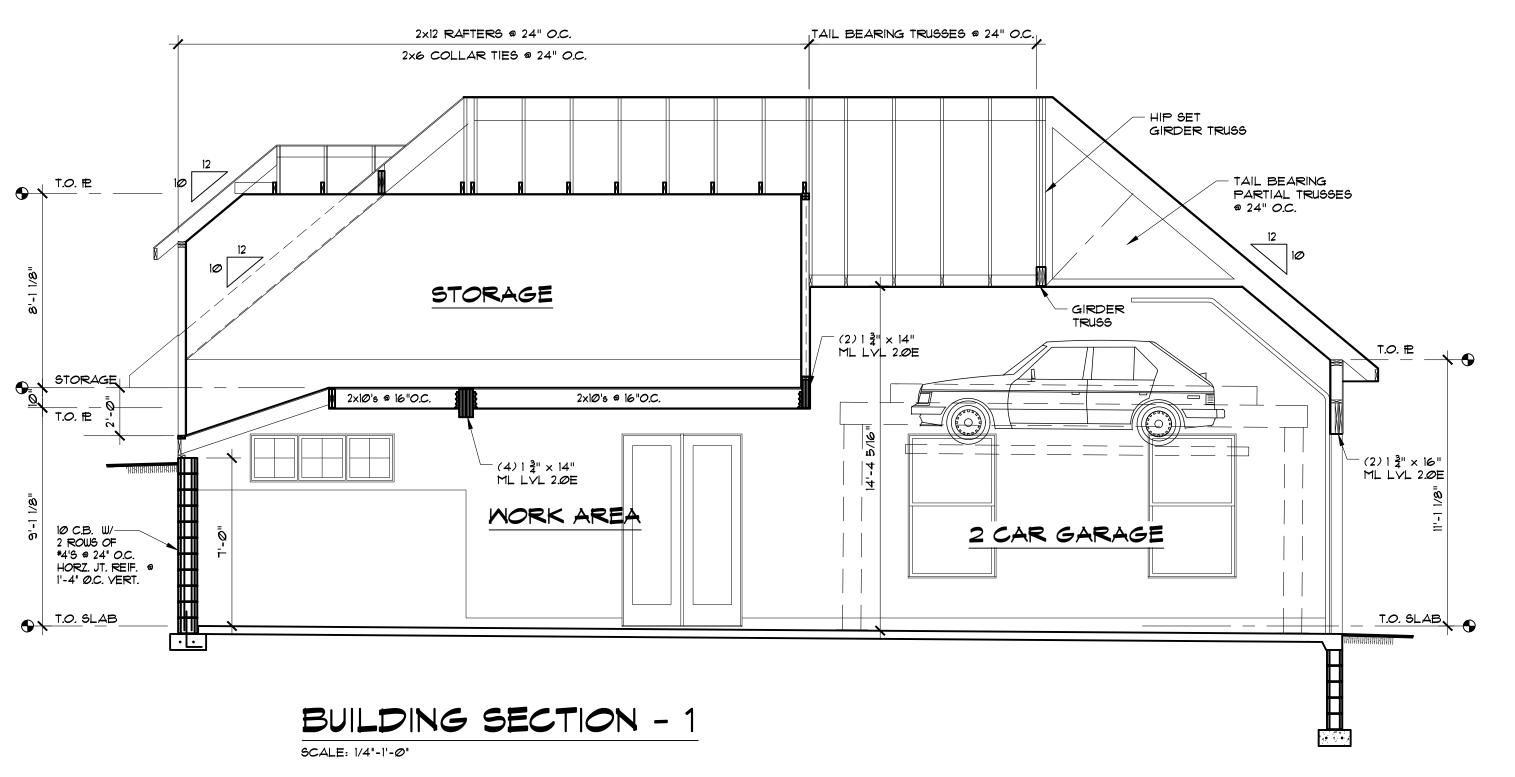
REVISIONS


DRAWING TITLE || First & Second ||Floor Plan


DRAWING INFORMATION Scale 1/4" = 1'-0"

Drawn CDT Checked RY Date Ø1-16-19 Job No. 19-006

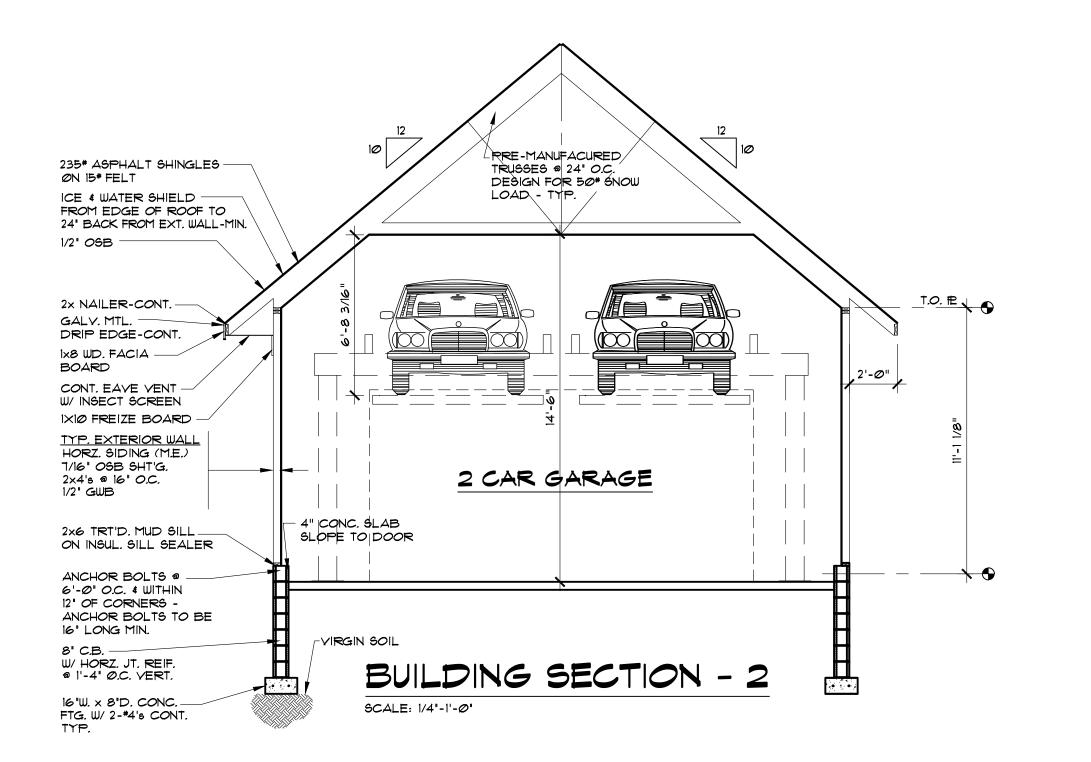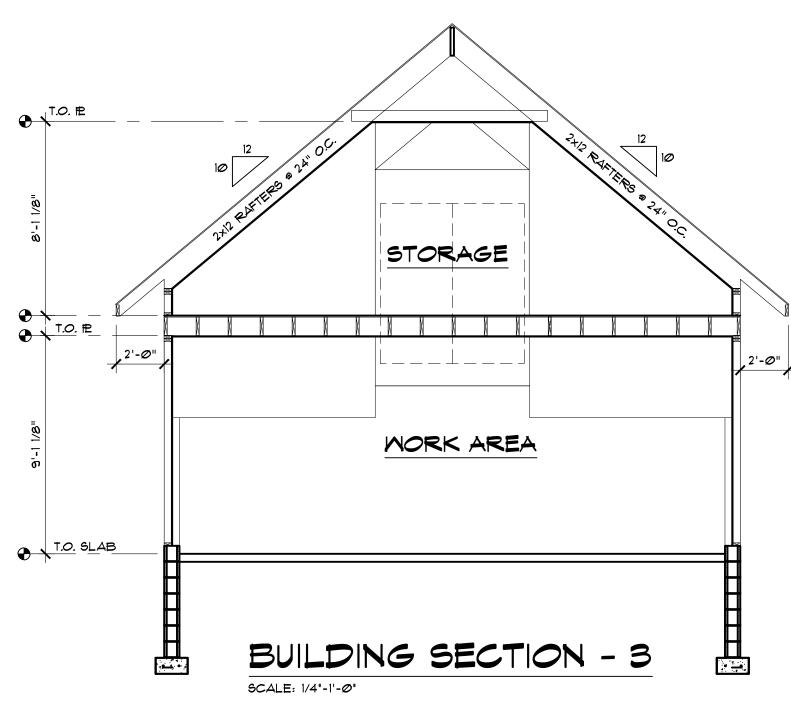DRAWING NUMBER







### **GENERAL NOTES:**

- All work is to comply with the 2015 International Residential Code and any applicable state, county or local codes.
   CODES GOVERN OVER DRAWINGS.
- The contractor is responsible to check plans and is to notify the architect of any errors or omissions prior to the start of construction.
- 3. Written dimensions have precedence over scaled dimensions. DO NOT
- 4. Insulation to meet the 2015 International Energy Efficiency Code. All exposed insulation is to have a flame spread rating of 25 or less and a smoke-developed index not to exceed 450 in accordance to ASTM E 84. Provide insulation baffles at eave between rafters.
- All exterior joints, Seams, or penetrations in building envelopes that are sources of air leakage shall be sealed with a durable sealant material per section 502.1.4.2 "Caulking and sealants" of the 2015 International Energy Efficiency Code
- 6. Structural steel shall be ASTM A-36.

SCALE THE DRAWINGS.

- 7. All Structural wood shall bear the mark of the grading rules agency having jurisdiction (following framing lumber guidelines).
- 8. 2015 International Residential Code, table R602.3 (1) fastener schedule for structural material shall be followed.

Exterior Covering of the N.Y.S. Residential Building Code.

support live and dead loads specified by applicable codes.

- All exterior finishes, siding and brick or stone veneer shall follow Section R703
- 10. Wood trusses shall be certified by the manufacturer to have the capacity to
- 11. All bearing wall openings to have headers:

  Typ Header @ 2x6 wall 3-2x10's (up to 6'-0")
  (unless specified otherwise)

  Typ Header @ 2x4 wall 2-2x10's (up to 6'-0")
  (unless specified otherwise)
   glue & nail all header assemblies typ.
- Joists that are attached to flush beams are to be hung with joist hangers or equivalent.
- 13. Provide double joists under all parallel partitions.
- Provide fireblocking draftstops & firestops per
   2015 International Residential Code Section R602.8
- 15. All beams & headers (over 6'-0" span) in bearing walls to have double stud bearing unless noted otherwise.
- All bearing to be continued to foundation or footing and have a minimum size equal to beam thickness.
- 17. Interior stud walls 2x4's @ 24" o.c. except where noted or at bearing walls, where spacing is 16" o.c..
- 18. Baths & Kitchens to have 1/2" water resistant GWB on all surfaces adjacent to
- 19. All wood decking & deck framing to be pressure treated.
- Ground fault interceptor outlets typical @ all baths, laundry, garage, exterior outlets and within 6'-0" of all sinks.
- Framing calculations are based on Spruce Pine Fir #2 (Kiln Dried) or better.
   Minimum Fb 775 for all beams and headers -typ.
- 22. In addition to the primary exit from each habitable space there shall be provided in each such space at least one opening for emergency use (door or window). Such opening shall have a minimum of 5.7 square feet with a minimum Height dimension of 24" and a width of 20", with bottom of opening no higher than 44" above finished floor.
- 23. All glazing in an individual fixed or operable panel, with exposed area of an individual pane larger than 9 square feet, whose bottom edge less than 18 inches above the floor. and top edge more than 36 inches above the floor, with one or more walking surfaces within 36 inches (914 mm) horizontally of the glazing, are to have tempered glazing.
- 24. Skylights are to be glazed with tempered glass on the outside and laminated glass on the inside (unless Plexiglas). Glass to have maximum clear span of 25". When installed on roofs of less than 3/12 pitch the Skylight frame is to be attached to a 2 x curb with a minimum of 4" above roof plane.
- 25. All tub or shower enclosures when glazed are to be glazed with safety glazing. All windows in building walls having a bottom edge of less than 60" above finish floor and enclosing a tub or shower are to have safety glazing.
- 26. All exterior window and door assemblies shall comply with the Maximum Allowable Infiltration Rate in table 502.1.4.1 of the 2015 International Energy Efficiency Code.

  Windows CFM per S.F. of window area 0.3 cfm max.

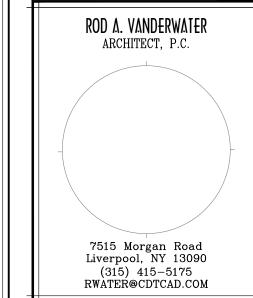
  Door CFM per S.F. of door area 0.5 cfm max.

  (Slider) 0.3 cfm max.

sections R303.3 and M1502.

- Connect all smoke detectors (see plan for location) to house electrical system
  and interconnect so when any one is tripped they will all sound. All smoke
  detectors shall have battery backup.
- 28. Provide combustion air vents (w/ screen and back damper) for fireplaces, wood stoves and any appliances with an open flame.
- 29. Bathrooms and Range Hoods are to be vented Per the NYS Residential code
- 30. Garage separation partition that has a 1/2 HR rating, One layer of 1/2" GWB may be installed on the garage side and One layer of 1/2" GWB may be installed on the opposite side. Application must comply with section R702.3 of the 2015 International Residential Code.
- 31. Ice protection An Ice barrier consisting of two layers of underlayment cemented together or a self-adhering polymer modified bitumen sheet, in lieu of normal underlayment and extend from the eaves edge to a point at least 24 inches inside the exterior wall line of the building.
- 32. Wall panels on either side of garage doors that do not comply with Table R602.10.5 must comply with APA's narrow wall bracing method. Provide metal straps, nailing and bolts as detailed in Figure 1 "Construction Details for the APA-narrow wall bracing method without hold-downs over concrete masonry block foundations" and have a maximum 6:1 portal frame ratio.
- Slope grade away from building minimum 6" in first 10' from building. comply with R401 of the 2015 International Residential Code
- 34. Windows shall have a minimum U value of .32 in Climate Zones 5 and 6 and shall bear a manufacture's energy efficiency label for inspection.





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Tatane Garage 104 Hampshire Road Syracuse, NY 13203

ONS

REVISIONS

Building Sections

DRAWING INFORMATION

Scale 1/4" = 1'-0"

Drawn CDT

Checked RY

Date 01-16-19

Job No. 19-006

DRAWING NUMBER

**A3** 

PROGRESS SET - ISSUED 03-12-19
NOT FOR CONSTRUCTION

### Auwaerter, Kate

From: Shawn Patane <skpatane@me.com>
Sent: Friday, March 15, 2019 2:58 PM

**To:** Auwaerter, Kate

**Subject:** Double Hung INTEGRITY

I made a goof on the window image...

It's a Marvin Integrity Double Hung window, I got that right. The image for the just did not have the correct number of dividers in case anyone is counting for the 3 by windows.. the will match the house in size.





Shawn



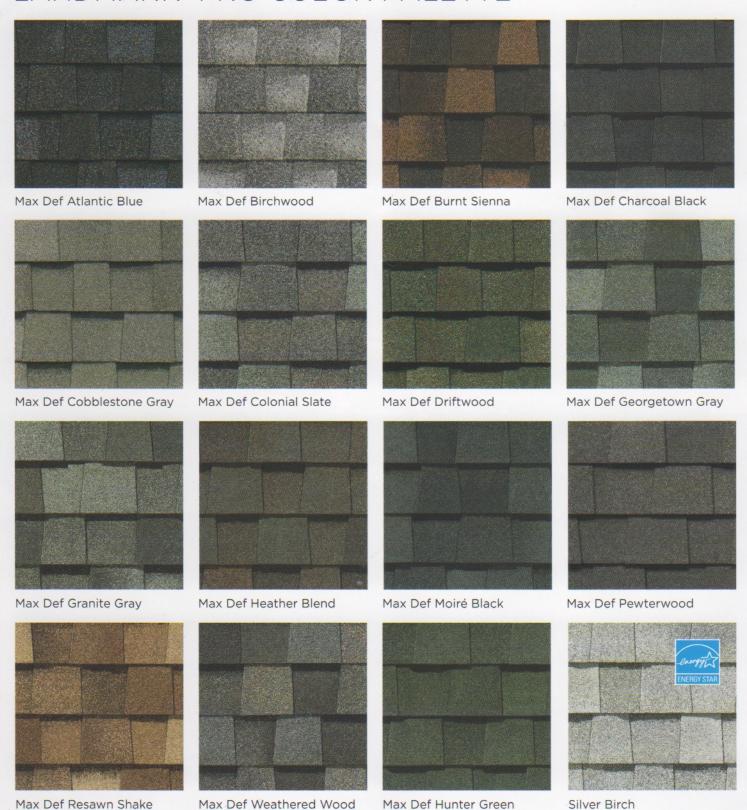


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Look deeper. With Max Def, a new dimension is added to shingles with a richer mixture of surface granules. You get a brighter, more vibrant, more dramatic appearance and depth of color. And the natural beauty of your roof shines through.

Landmark Pro Silver Birch is an ENERGY STAR® rated product and may qualify for a federal tax credit.